
32 RICKETTY STREET MASGOT, NSW 20


DEVELOPMENT APPLICATION

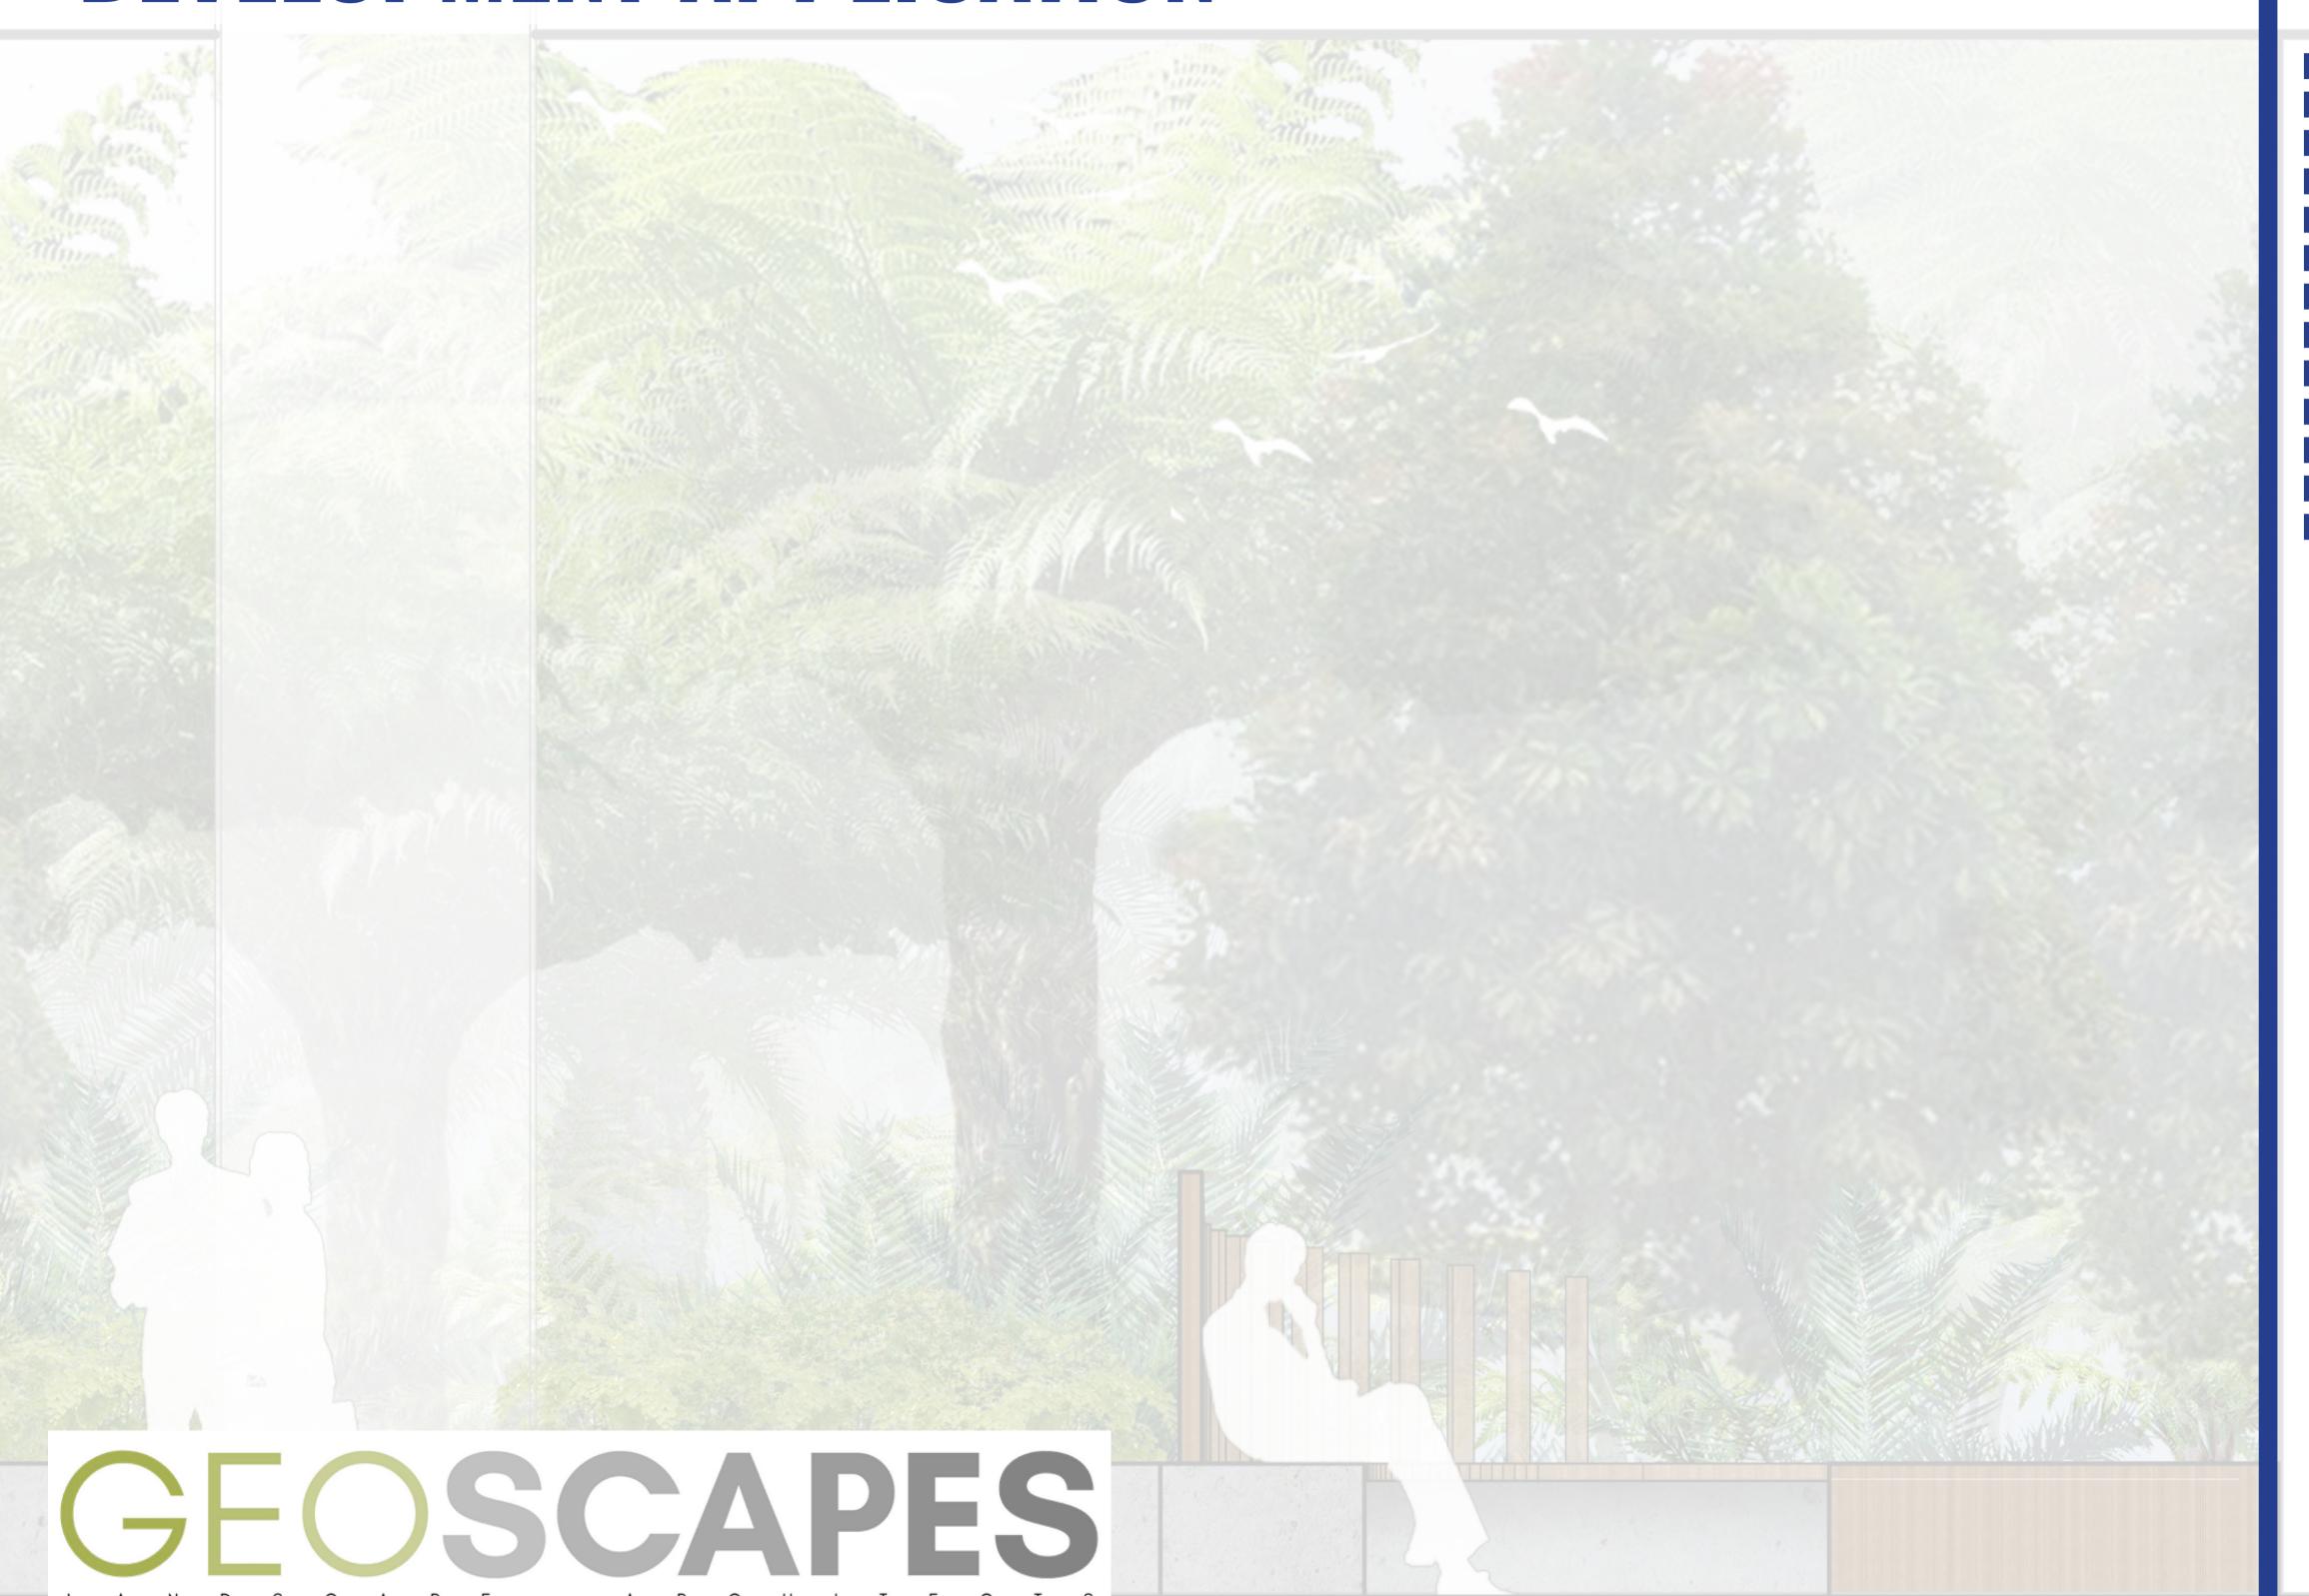


DRAWING REGISTER

DA-000 DA-101 DA-102 DA-103 DA-104 DA-105 DA-106 DA-107 DA-108 DA-109 DA-110 DA-111	Landscape Cover Sheet Public Domain Plan Ground Floor Layout Ground Floor North - Detail Plan Ground Floor South - Detail Plan Typical Levels 1-3 & Level 4 Terrace - Detail Plan & Details Typical Levels 5-9 - Detail Plan & Details Level 10 Green Roof - Detail Plan & Details Level 10 Communal Open Space - Detail Plan & Details Landscape Details Sheet 1 Landscape Details Sheet 2 Landscape Maintenance Plan & Specification Notes Planting Schedules & Hard and Soft Material Palette


LEGEND

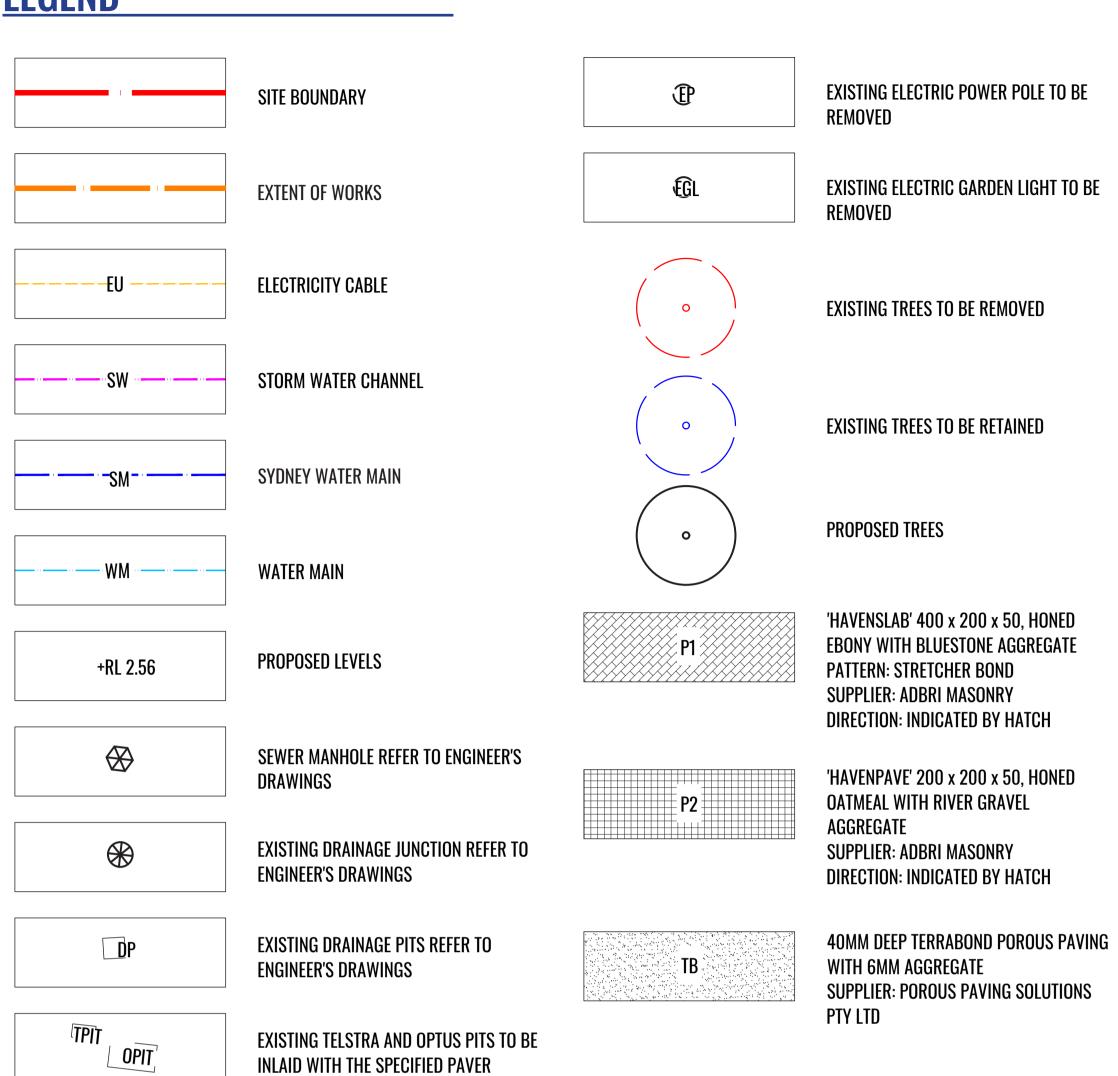

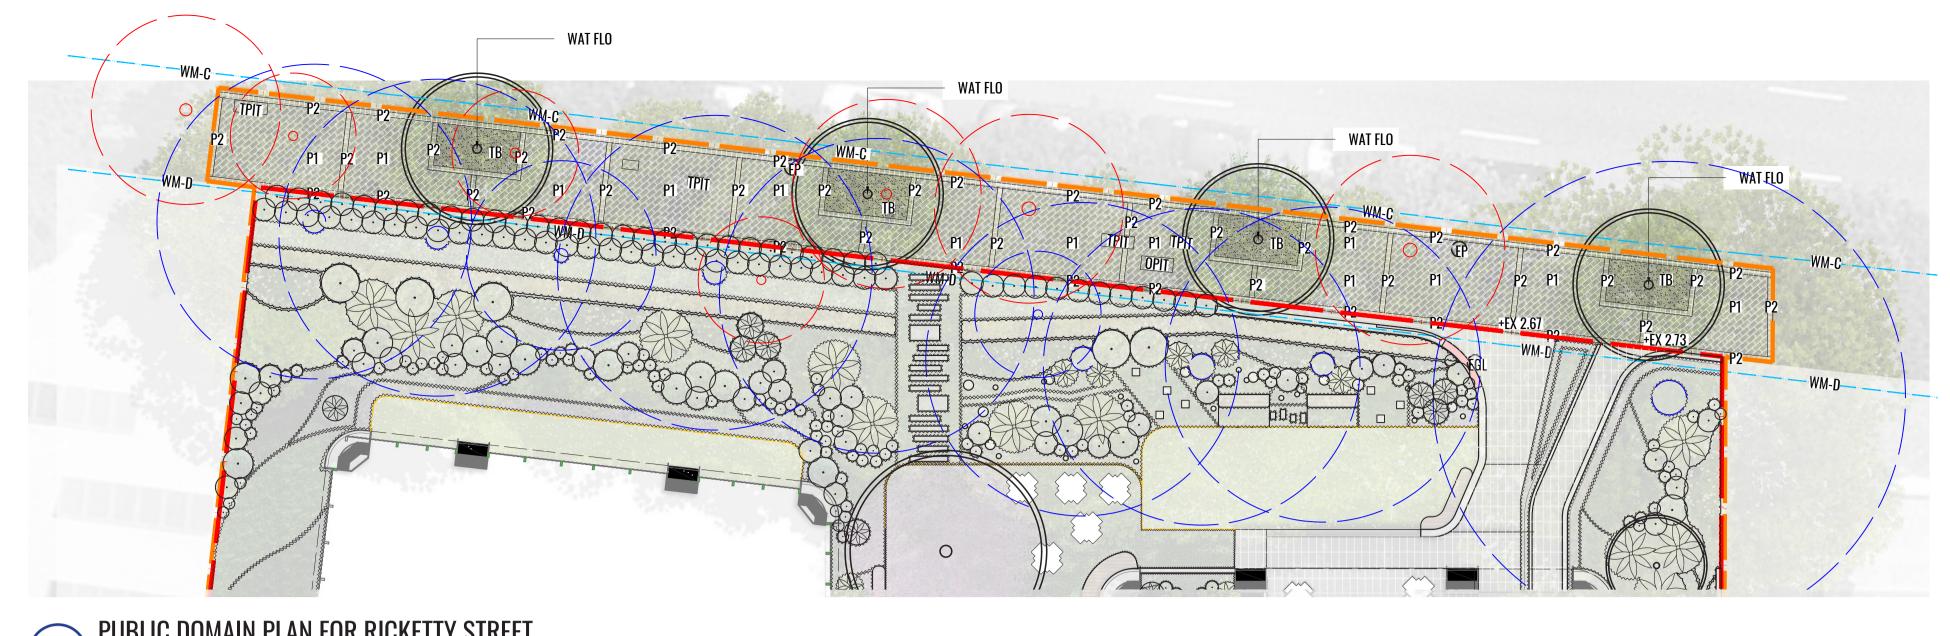

PUBLIC DOMAIN PLAN FOR RICKETTY STREET

Scale 1:150

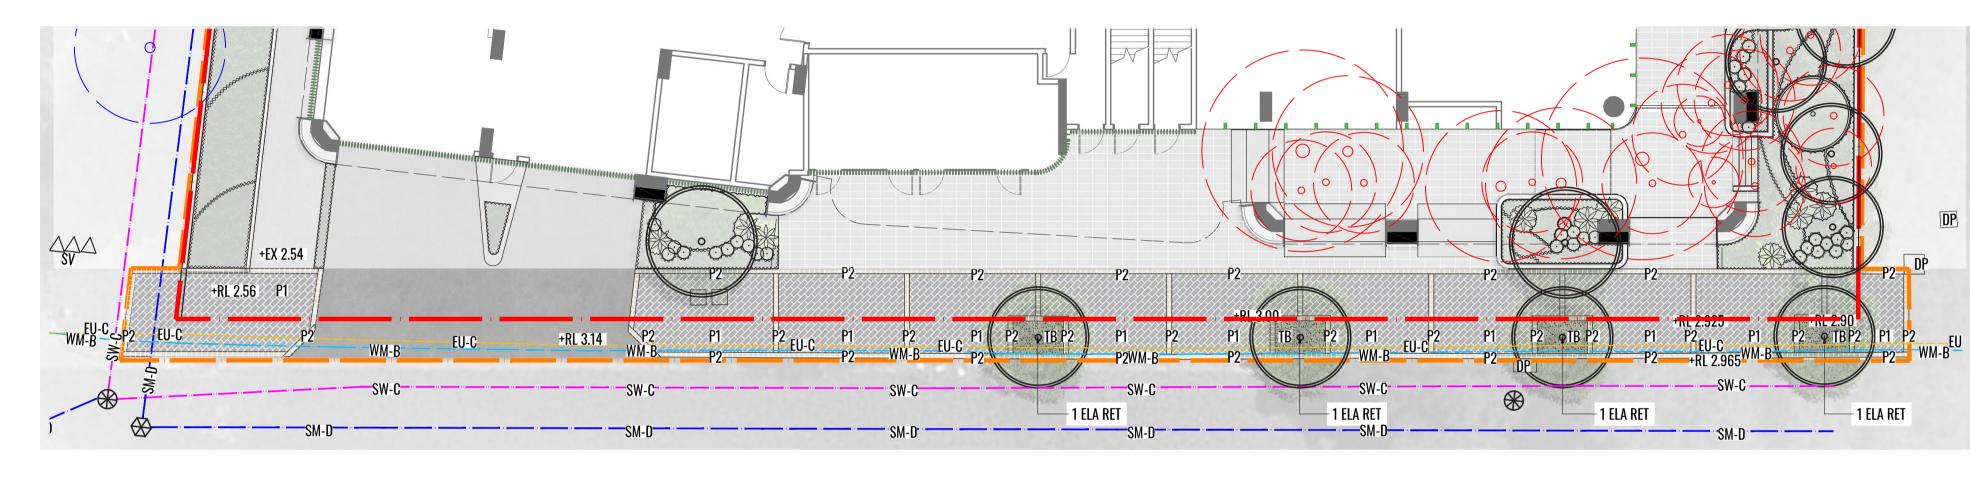

PUBLIC DOMAIN PLAN FOR OSSARY STREET

PRIMARY FEATURE PAVER


PAVERS

Havenslab 400x200x50mmHoned ebony with Bluestone aggregate



SECONDARY FEATURE PAVER

Havenslab 200x200x50mmHoned ebony with River gravel aggregate

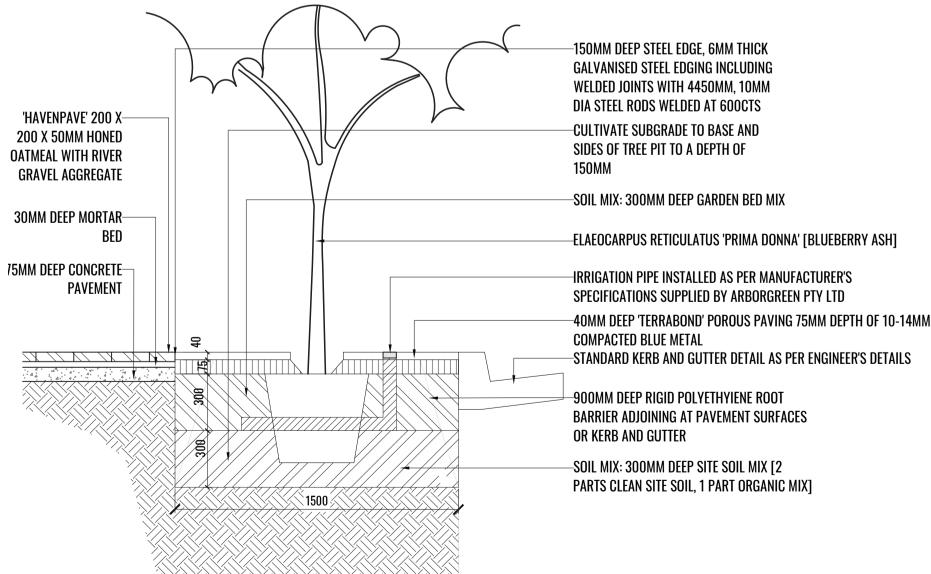

-HEADERS/BANDING PAVING: C & M BRICK HAVENSLAB 200X200X50mm HONED OATMEAL WITH -HEADERS/BANDING PAVING: FINE RIVER GRAVEL AGGREGATE OR COUNCIL APPROVED EQUIVALENT C & M BRICK HAVENSLAB 200X200X50mm HONED OATMEAL WITH FINE PATTERN: STRETCHER BOND RIVER GRAVEL AGGREGATE OR COUNCIL APPROVED EQUIVALENT PATTERN: STRETCHER BOND -40MM DEEP 'TERRABOND' POROUS PAVING -INFIL PAVING: C & M BRICK HAVENSLAB -40MM DEEP 'TERRABOND' POROUS PAVING —INFIL PAVING: 400X200X50/60mm HONED EBONY C & M BRICK HAVENSLAB 400X200X50/60mm HONED EBONY WITH BLUESTONE AGGREGATE OR WITH BLUESTONE AGGREGATE OR COUNCIL APPROVED EQUIVALENT COUNCIL APPROVED EQUIVALENT PATTERN: 45 DEGREE STRETCHER BOND PATTERN: 45 DEGREE STRETCHER BOND PROPERTY BOUNDARY 3300 KERB AND GUTTER KERB AND GUTTER **DETAIL PLAN FOR OSSARY STREET** DETAIL PLAN FOR RICKETTY STREET Scale 1:50 Scale 1:50

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TREE PIT DETAIL

Scale 1:20



Drawing Title:


PUBLIC DOMAIN


Detail Plan


DWG No:


FOR DEVELOPMENT APPLICATION Scale: Job Number: North: Revision Date: 1:150 @ A1 RevDateDescriptionA14.12.20FOR DA Drawn Checked 27.05.2021 200922 1:300 @ A3 TW/PT **B** 29.04.21 FOR DA 32 Ricketty St **C** 27.05.21 FOR DA PT BG Mascot, NSW 2020




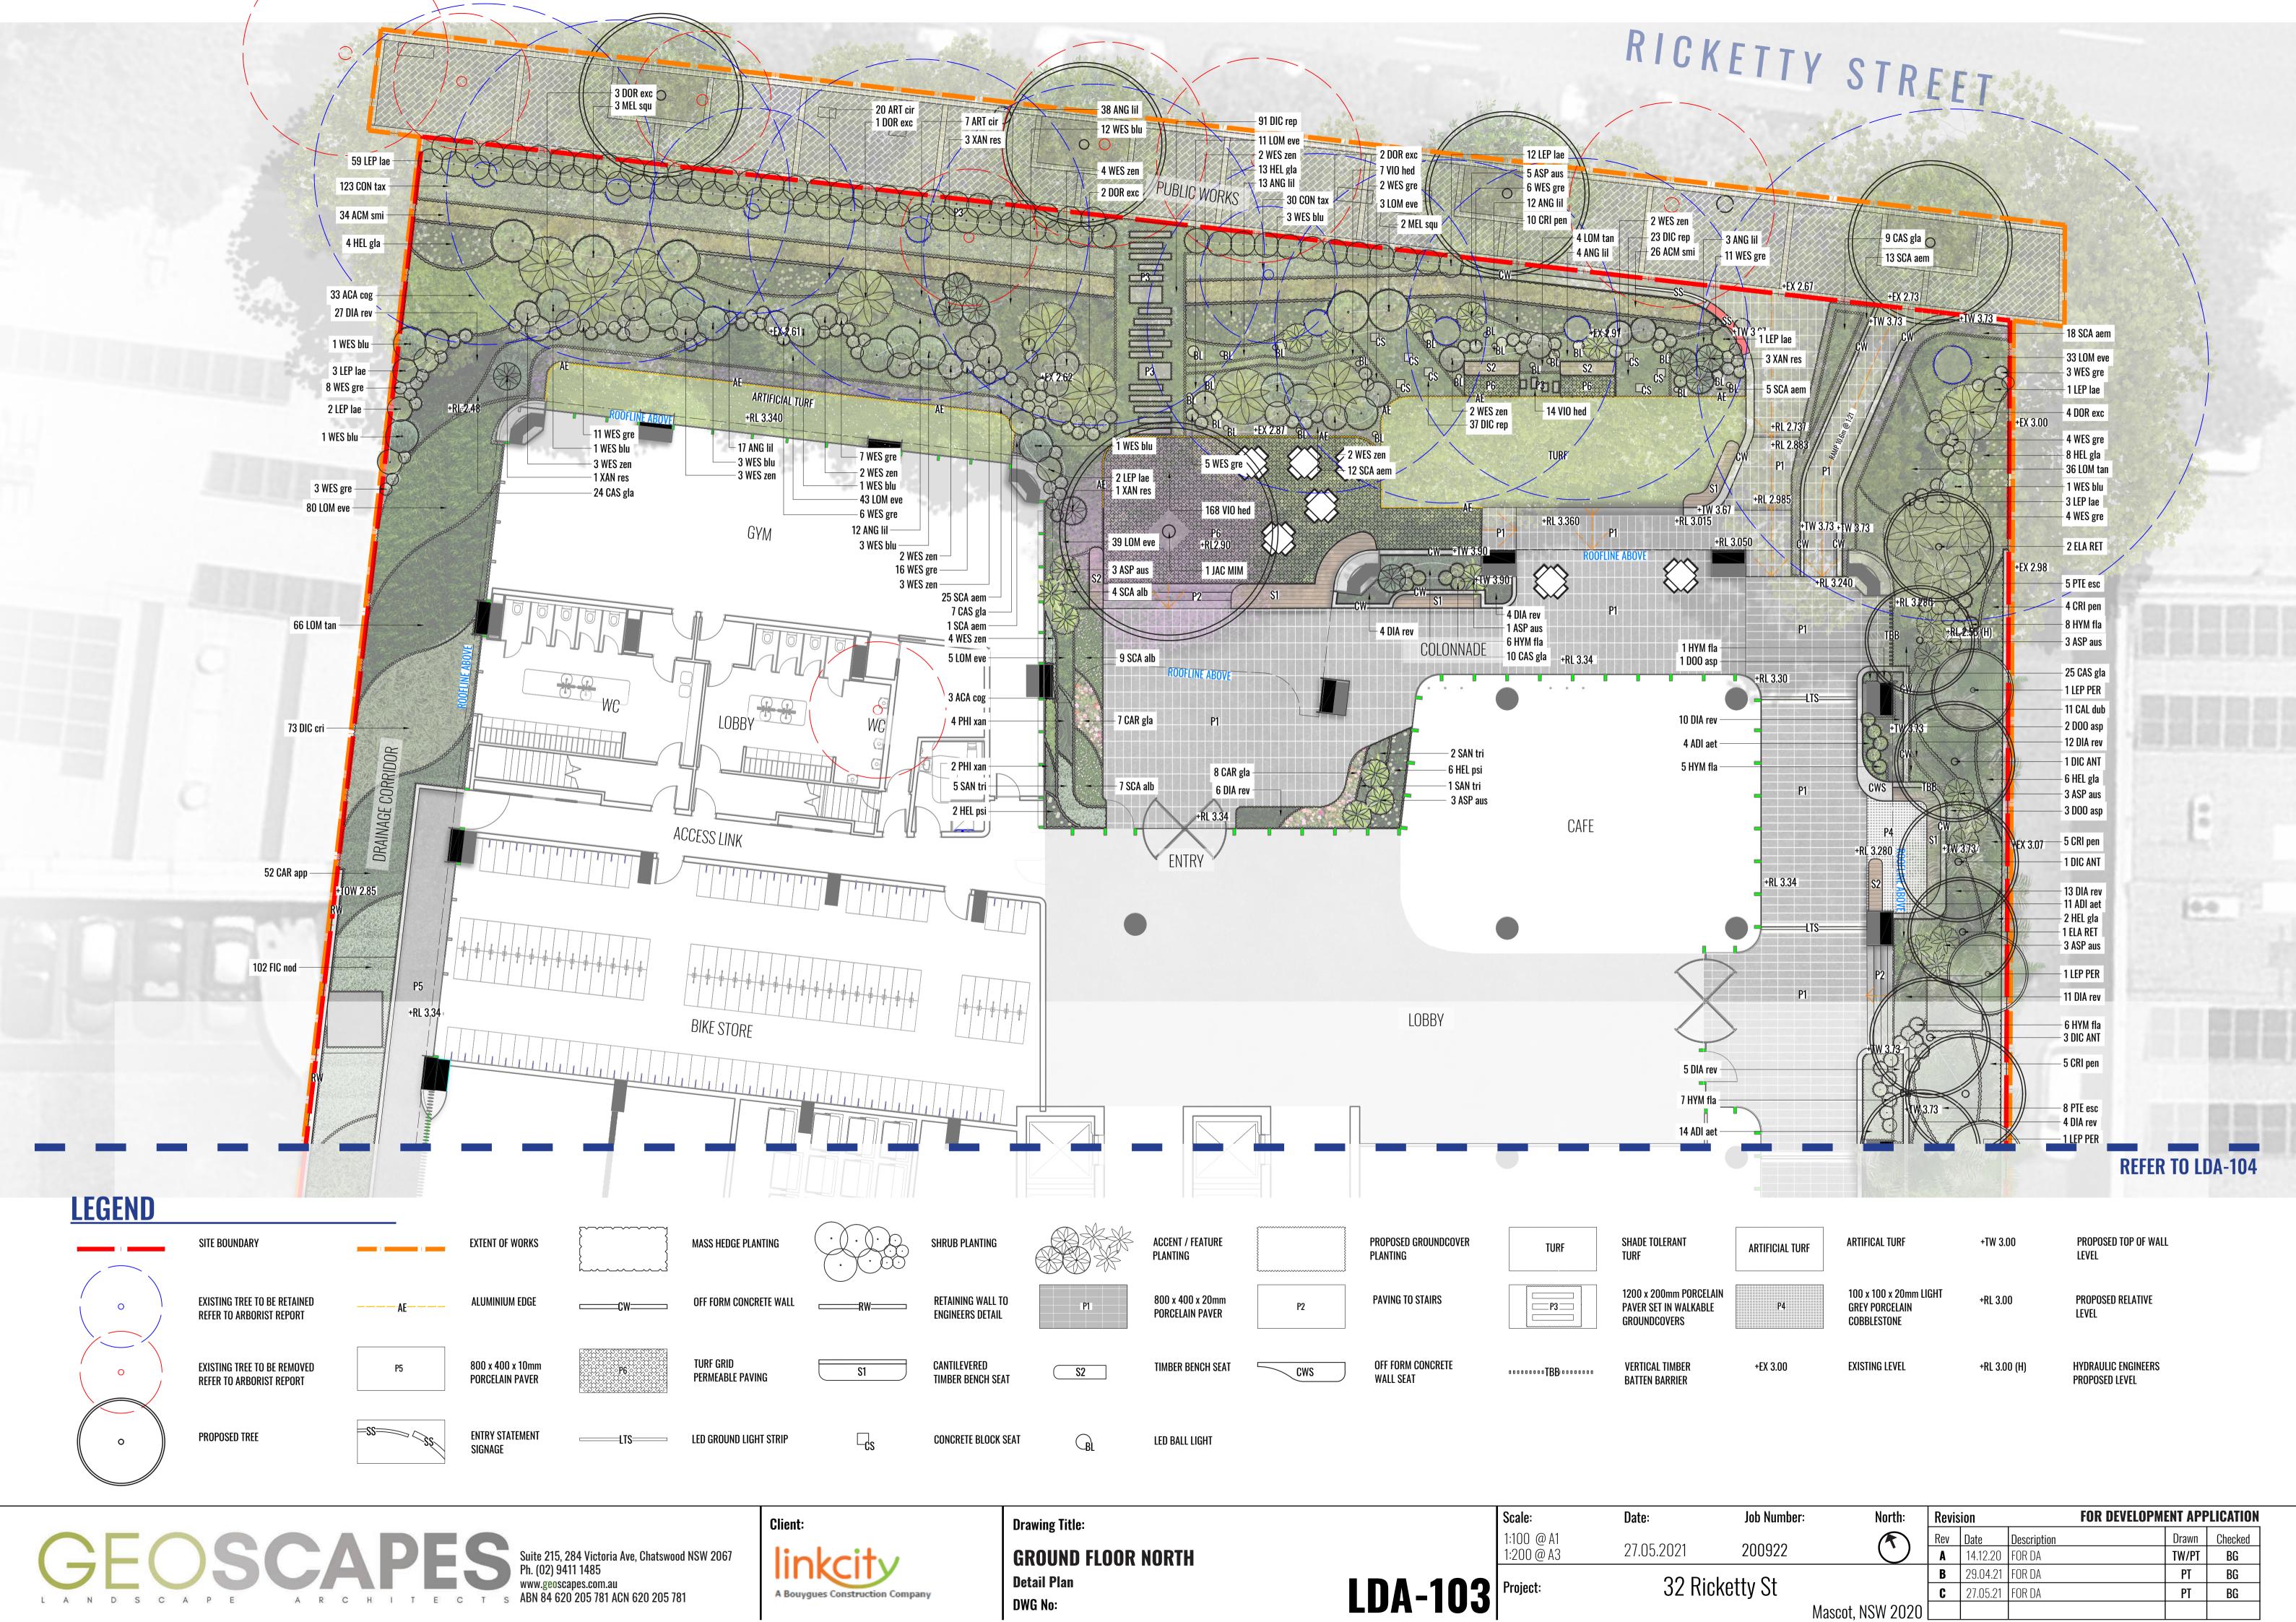

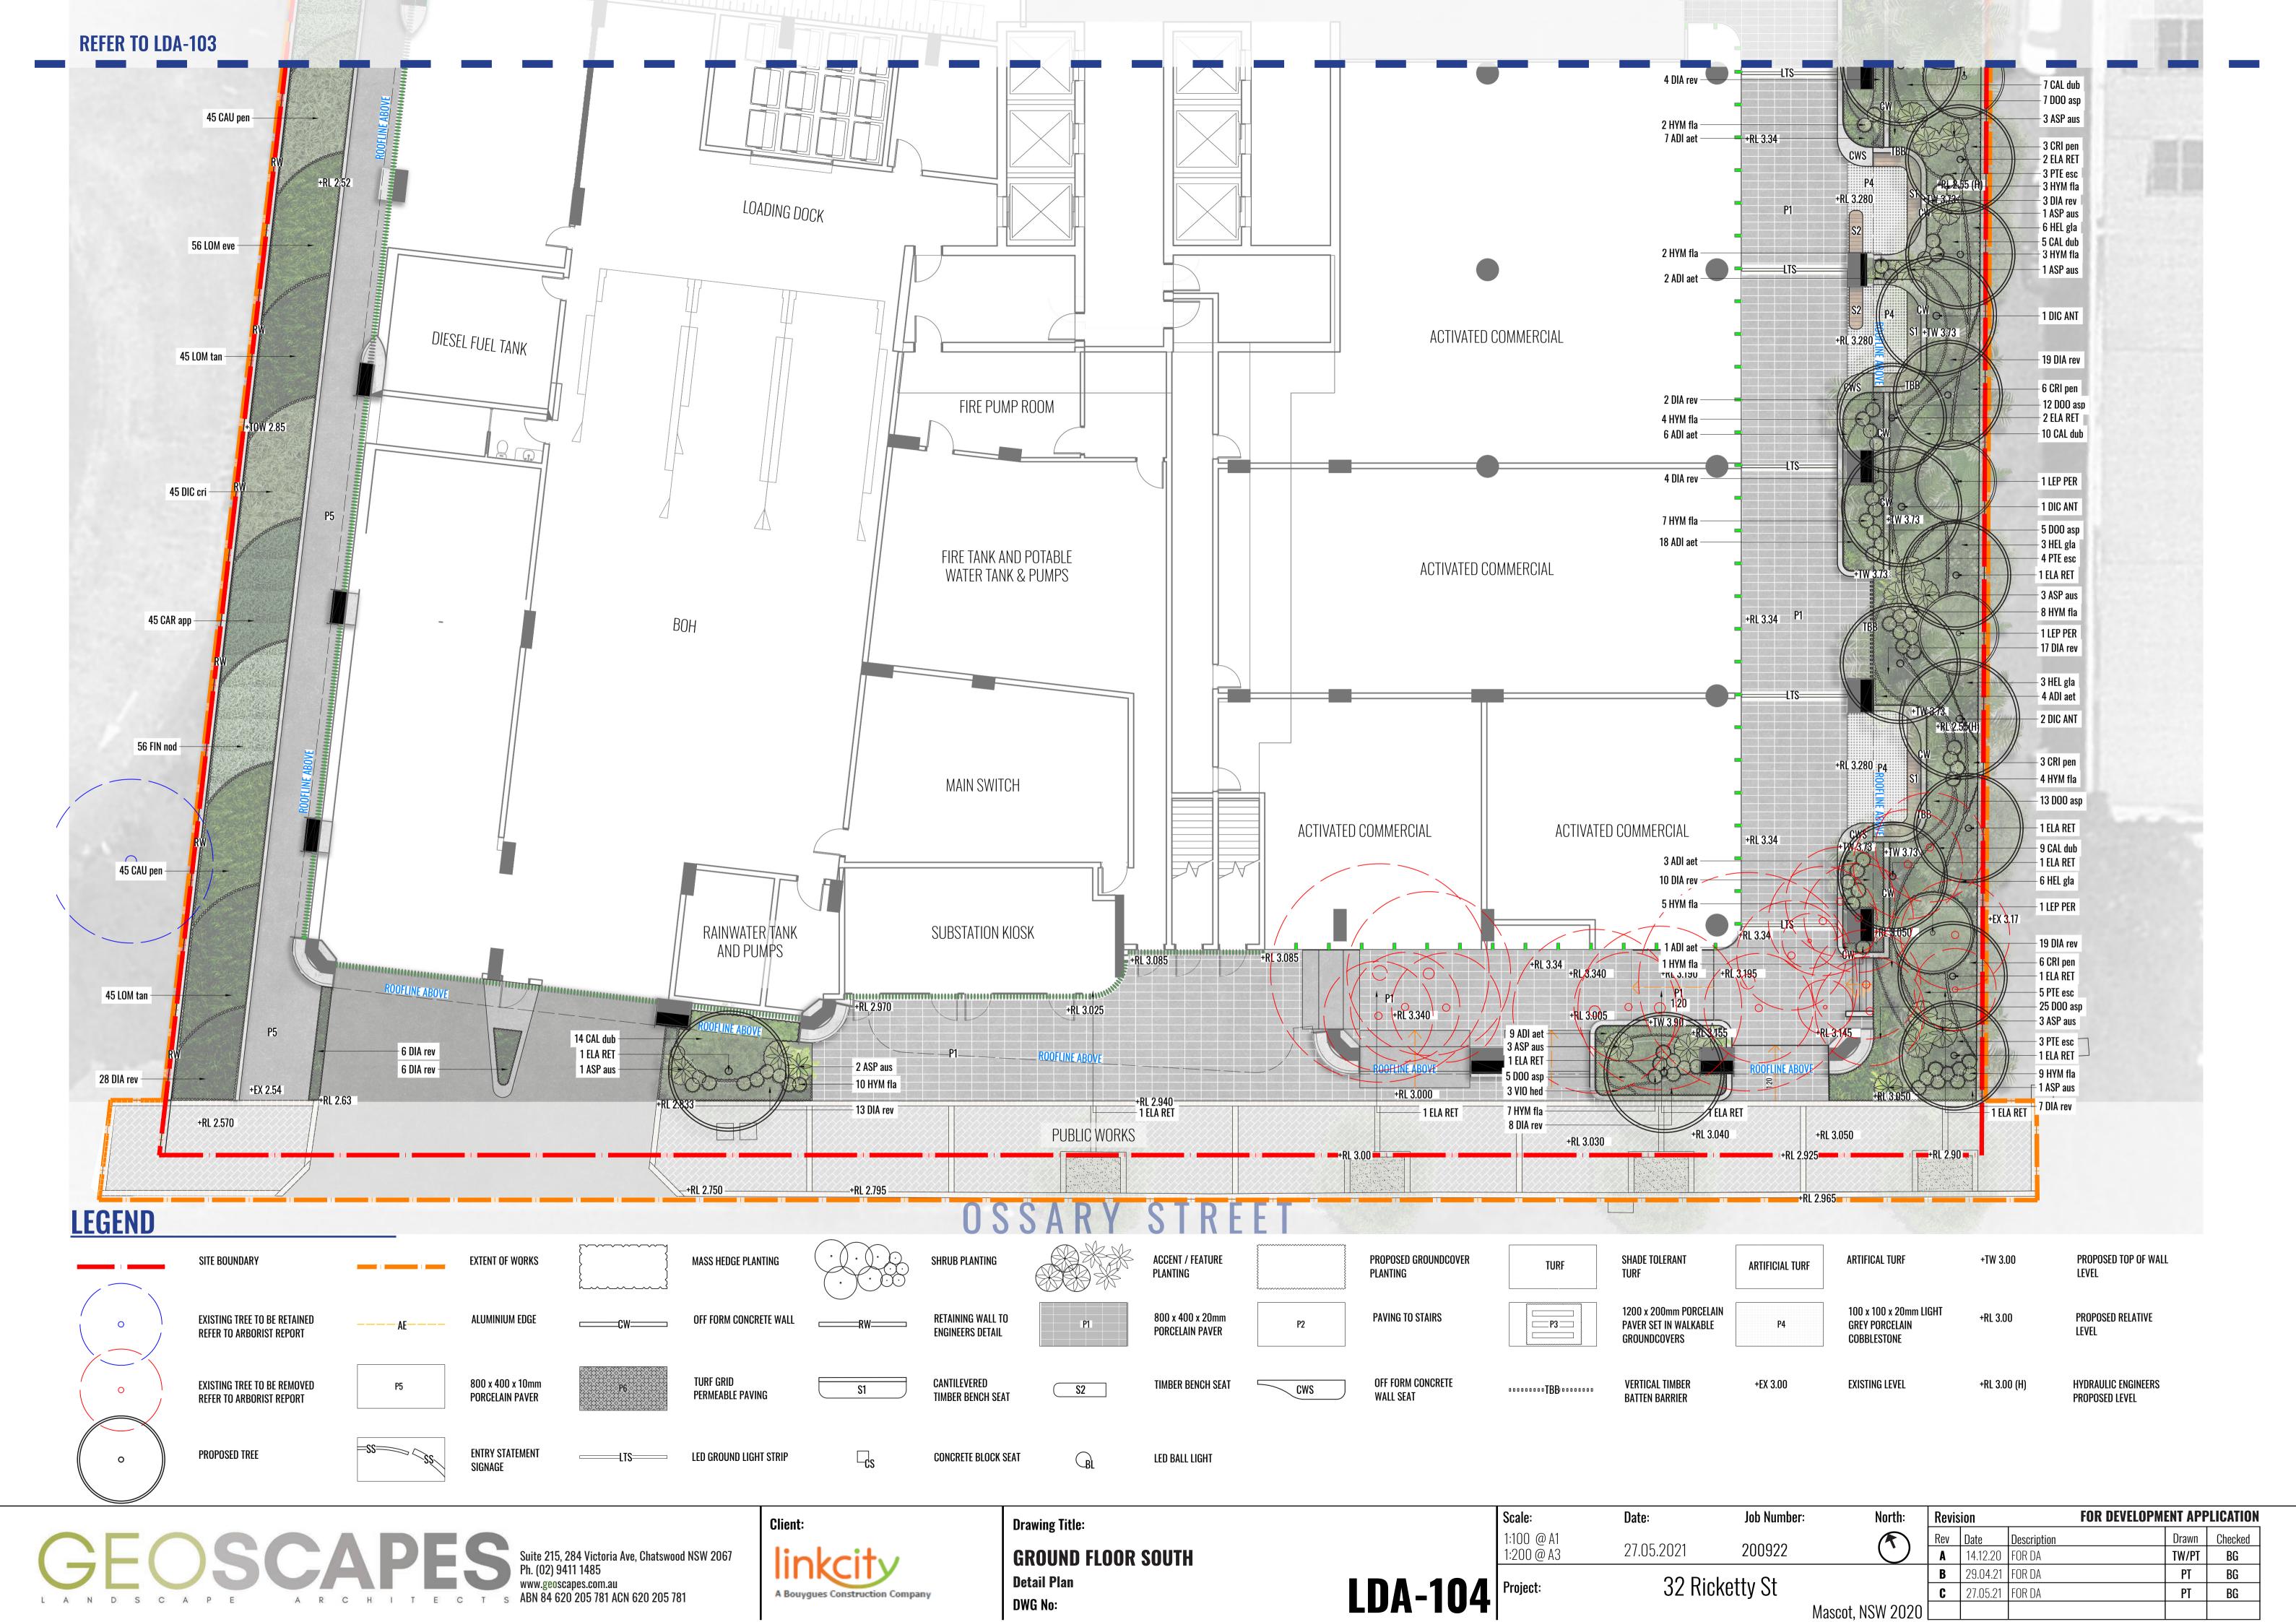

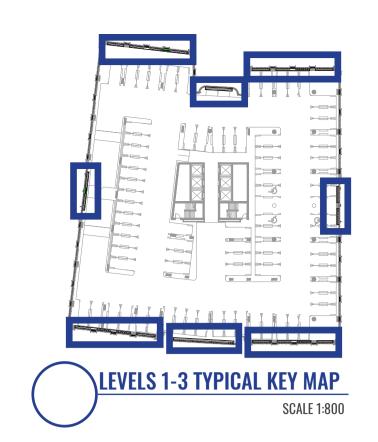

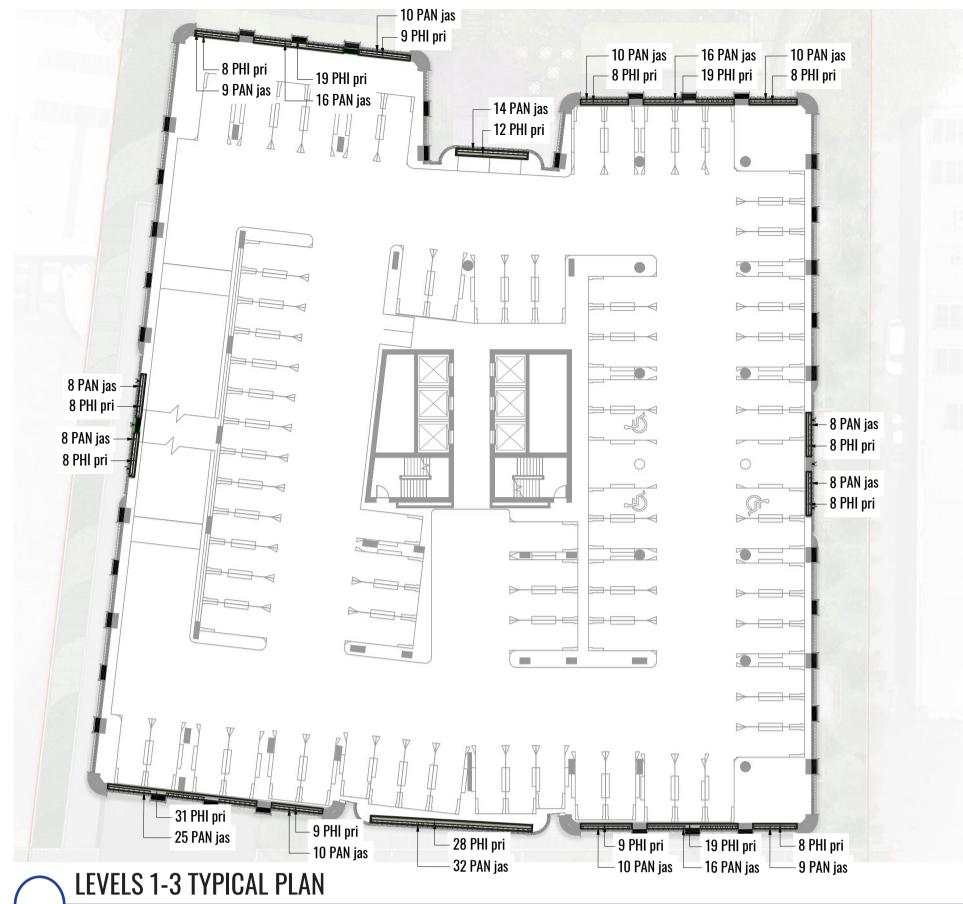

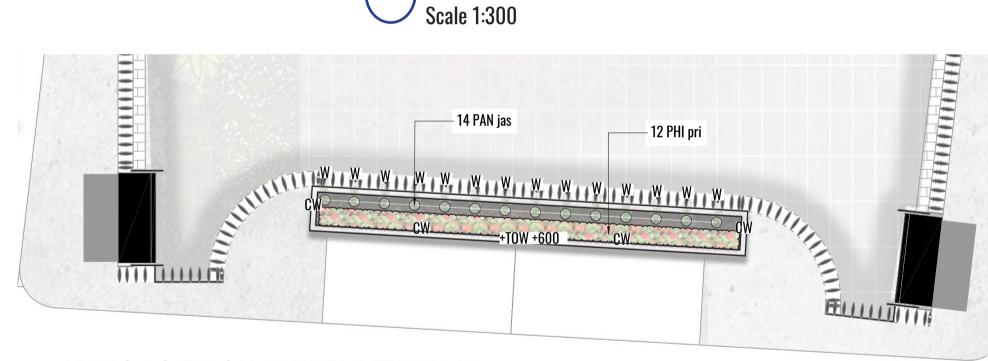


LEGEND

PROPOSED GROUNDCOVER PLANTING PROPOSED CLIMBING PLANTS 0000000 CONCRETE WALL TO ARCHITECT DETAIL TENSILE STEEL WIRE PROPOSED WALL HEIGHT

LEVELS 1-3 TYPICAL PLANTER DETAIL PLAN

Scale 1:50

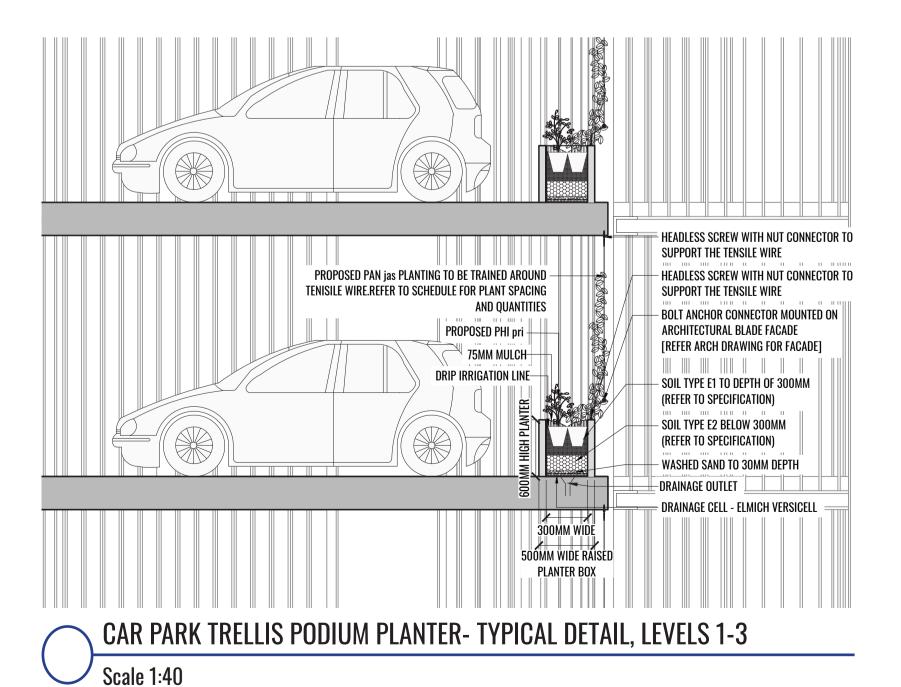

A R C H I T E C T S ABN 84 620 205 781 ACN 620 205 781

A Bouygues Construction Company


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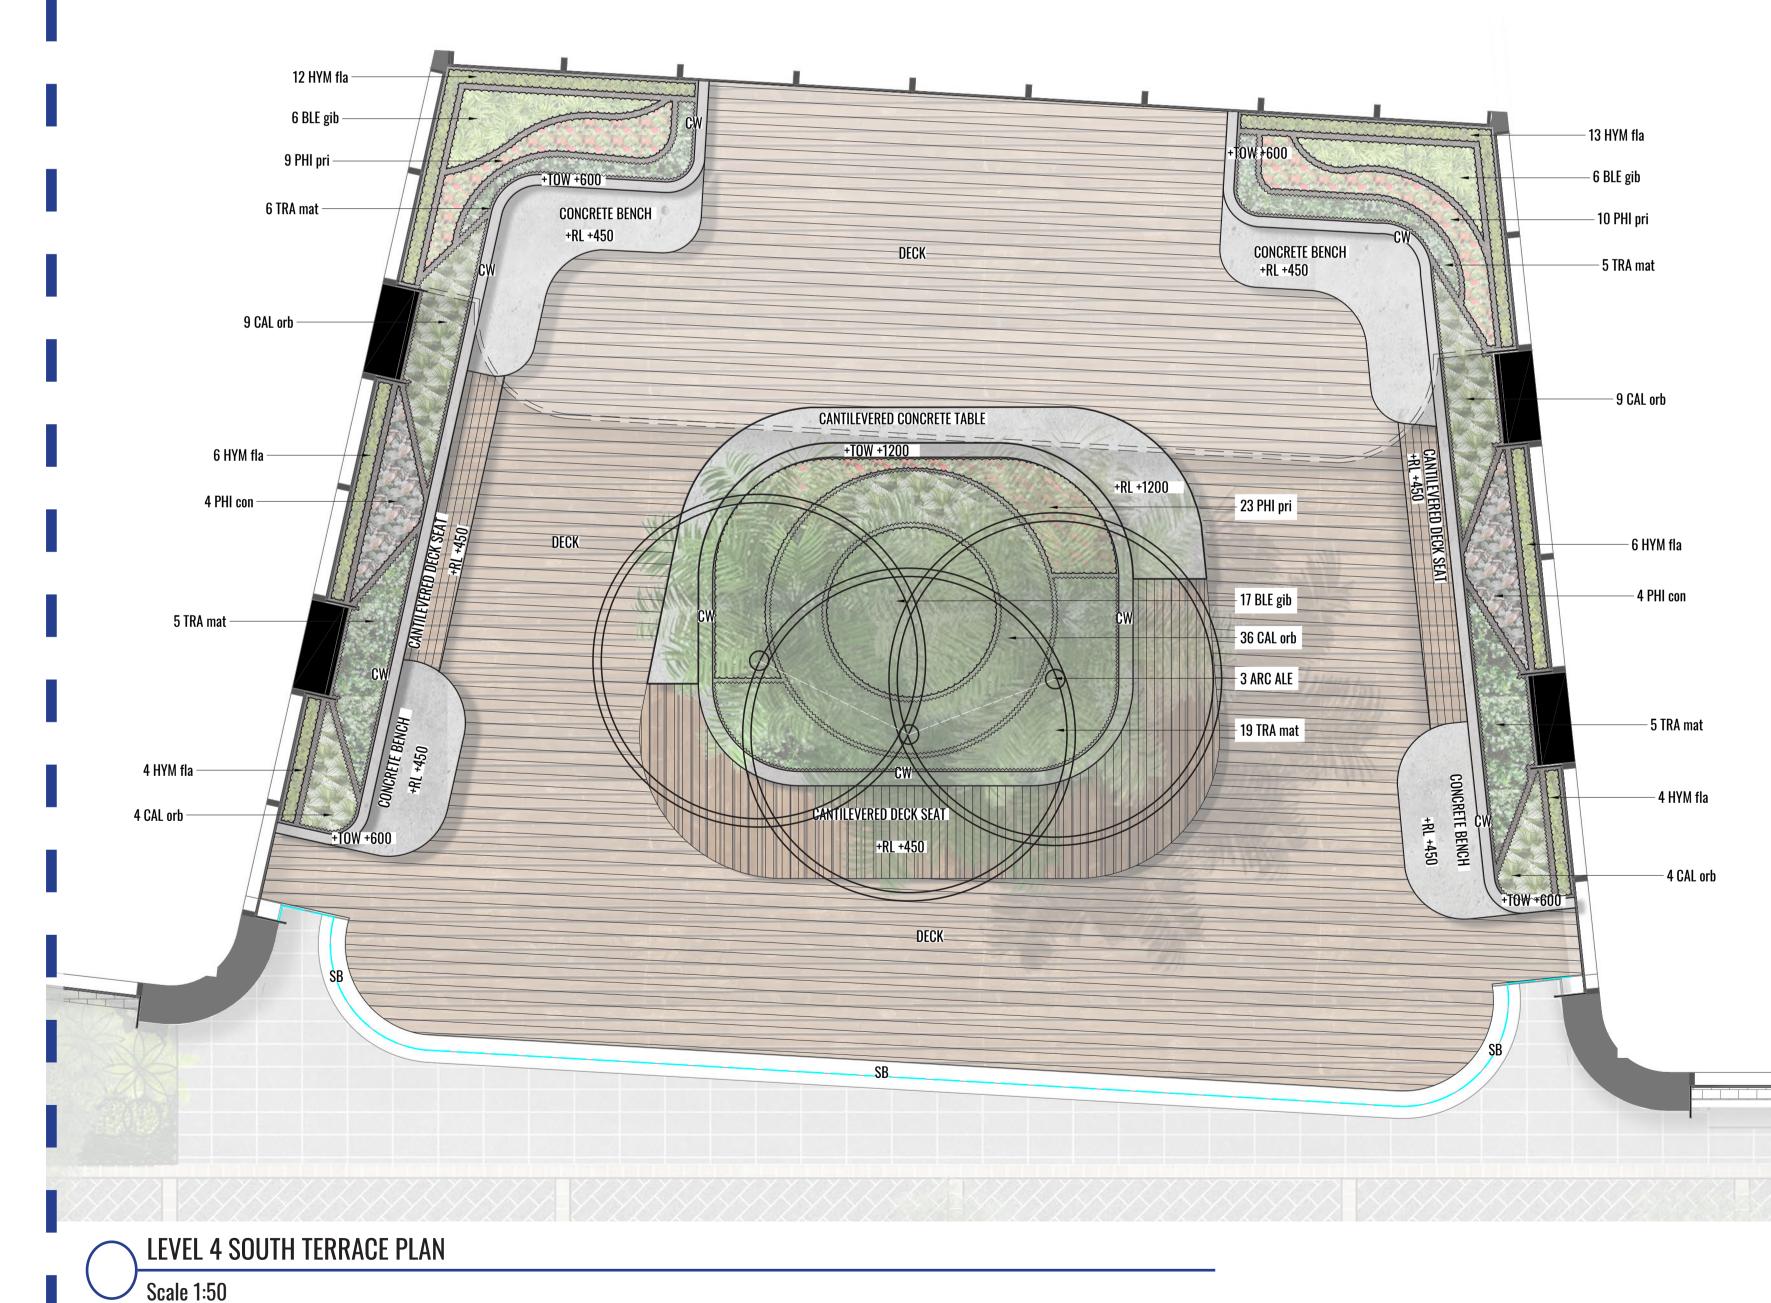
DWG No:

TYPICAL LEVELS 1-3 & LEVEL 4 TERRACE Detail Plan & Details

LDA-105 Project:

FOR DEVELOPMENT APPLICATION Scale: Date: Job Number: North: Revision As Shown RevDateDescriptionA14.12.20FOR DA Checked 27.05.2021 200922 TW/PT BG **B** 29.04.21 FOR DA 32 Ricketty St **C** 27.05.21 FOR DA BG PT Mascot, NSW 2020



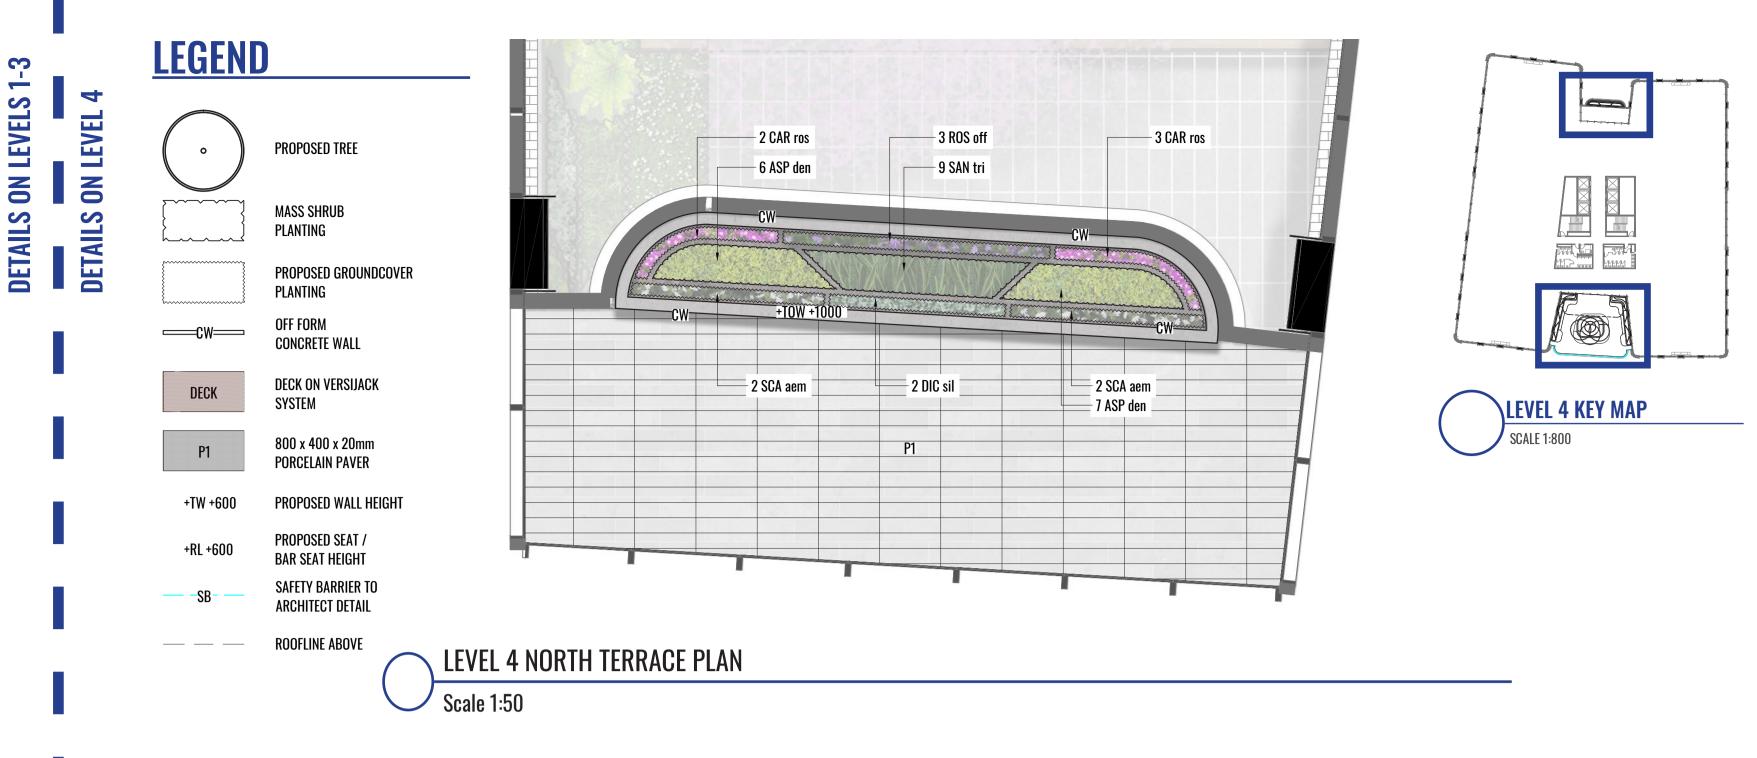

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ADM 94 620 205 791 ACM 620 205 791



LEGEND

MASS SHRUB
PLANTING


PROPOSED GROUNDCOVER

PLANTING

OFF FORM
CONCRETE WALL

P1 800 x 400 x 20mm PORCELAIN PAVER

+TW +600 PROPOSED WALL HEIGHT

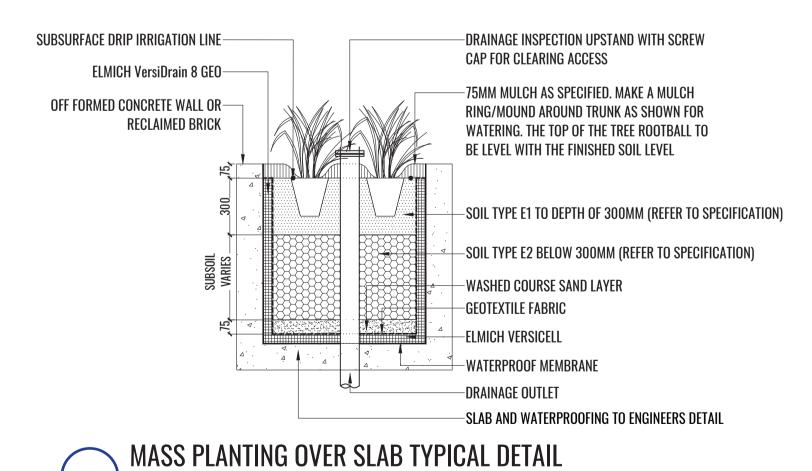



Drawing Title:

TYPICAL LEVELS 5-9


Detail Plan & Details

DWG No:

1:150 @ A1 1:300 @ A3 Project:

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1:150 @ A1	07.05.0001	000000		Rev	Date	Description		Drawn	Checked
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Project:	32 KIO	cketty St		C	27.05.21	FOR DA		PT	BG
			Mascot, NSW 2020						

Scale 1:20

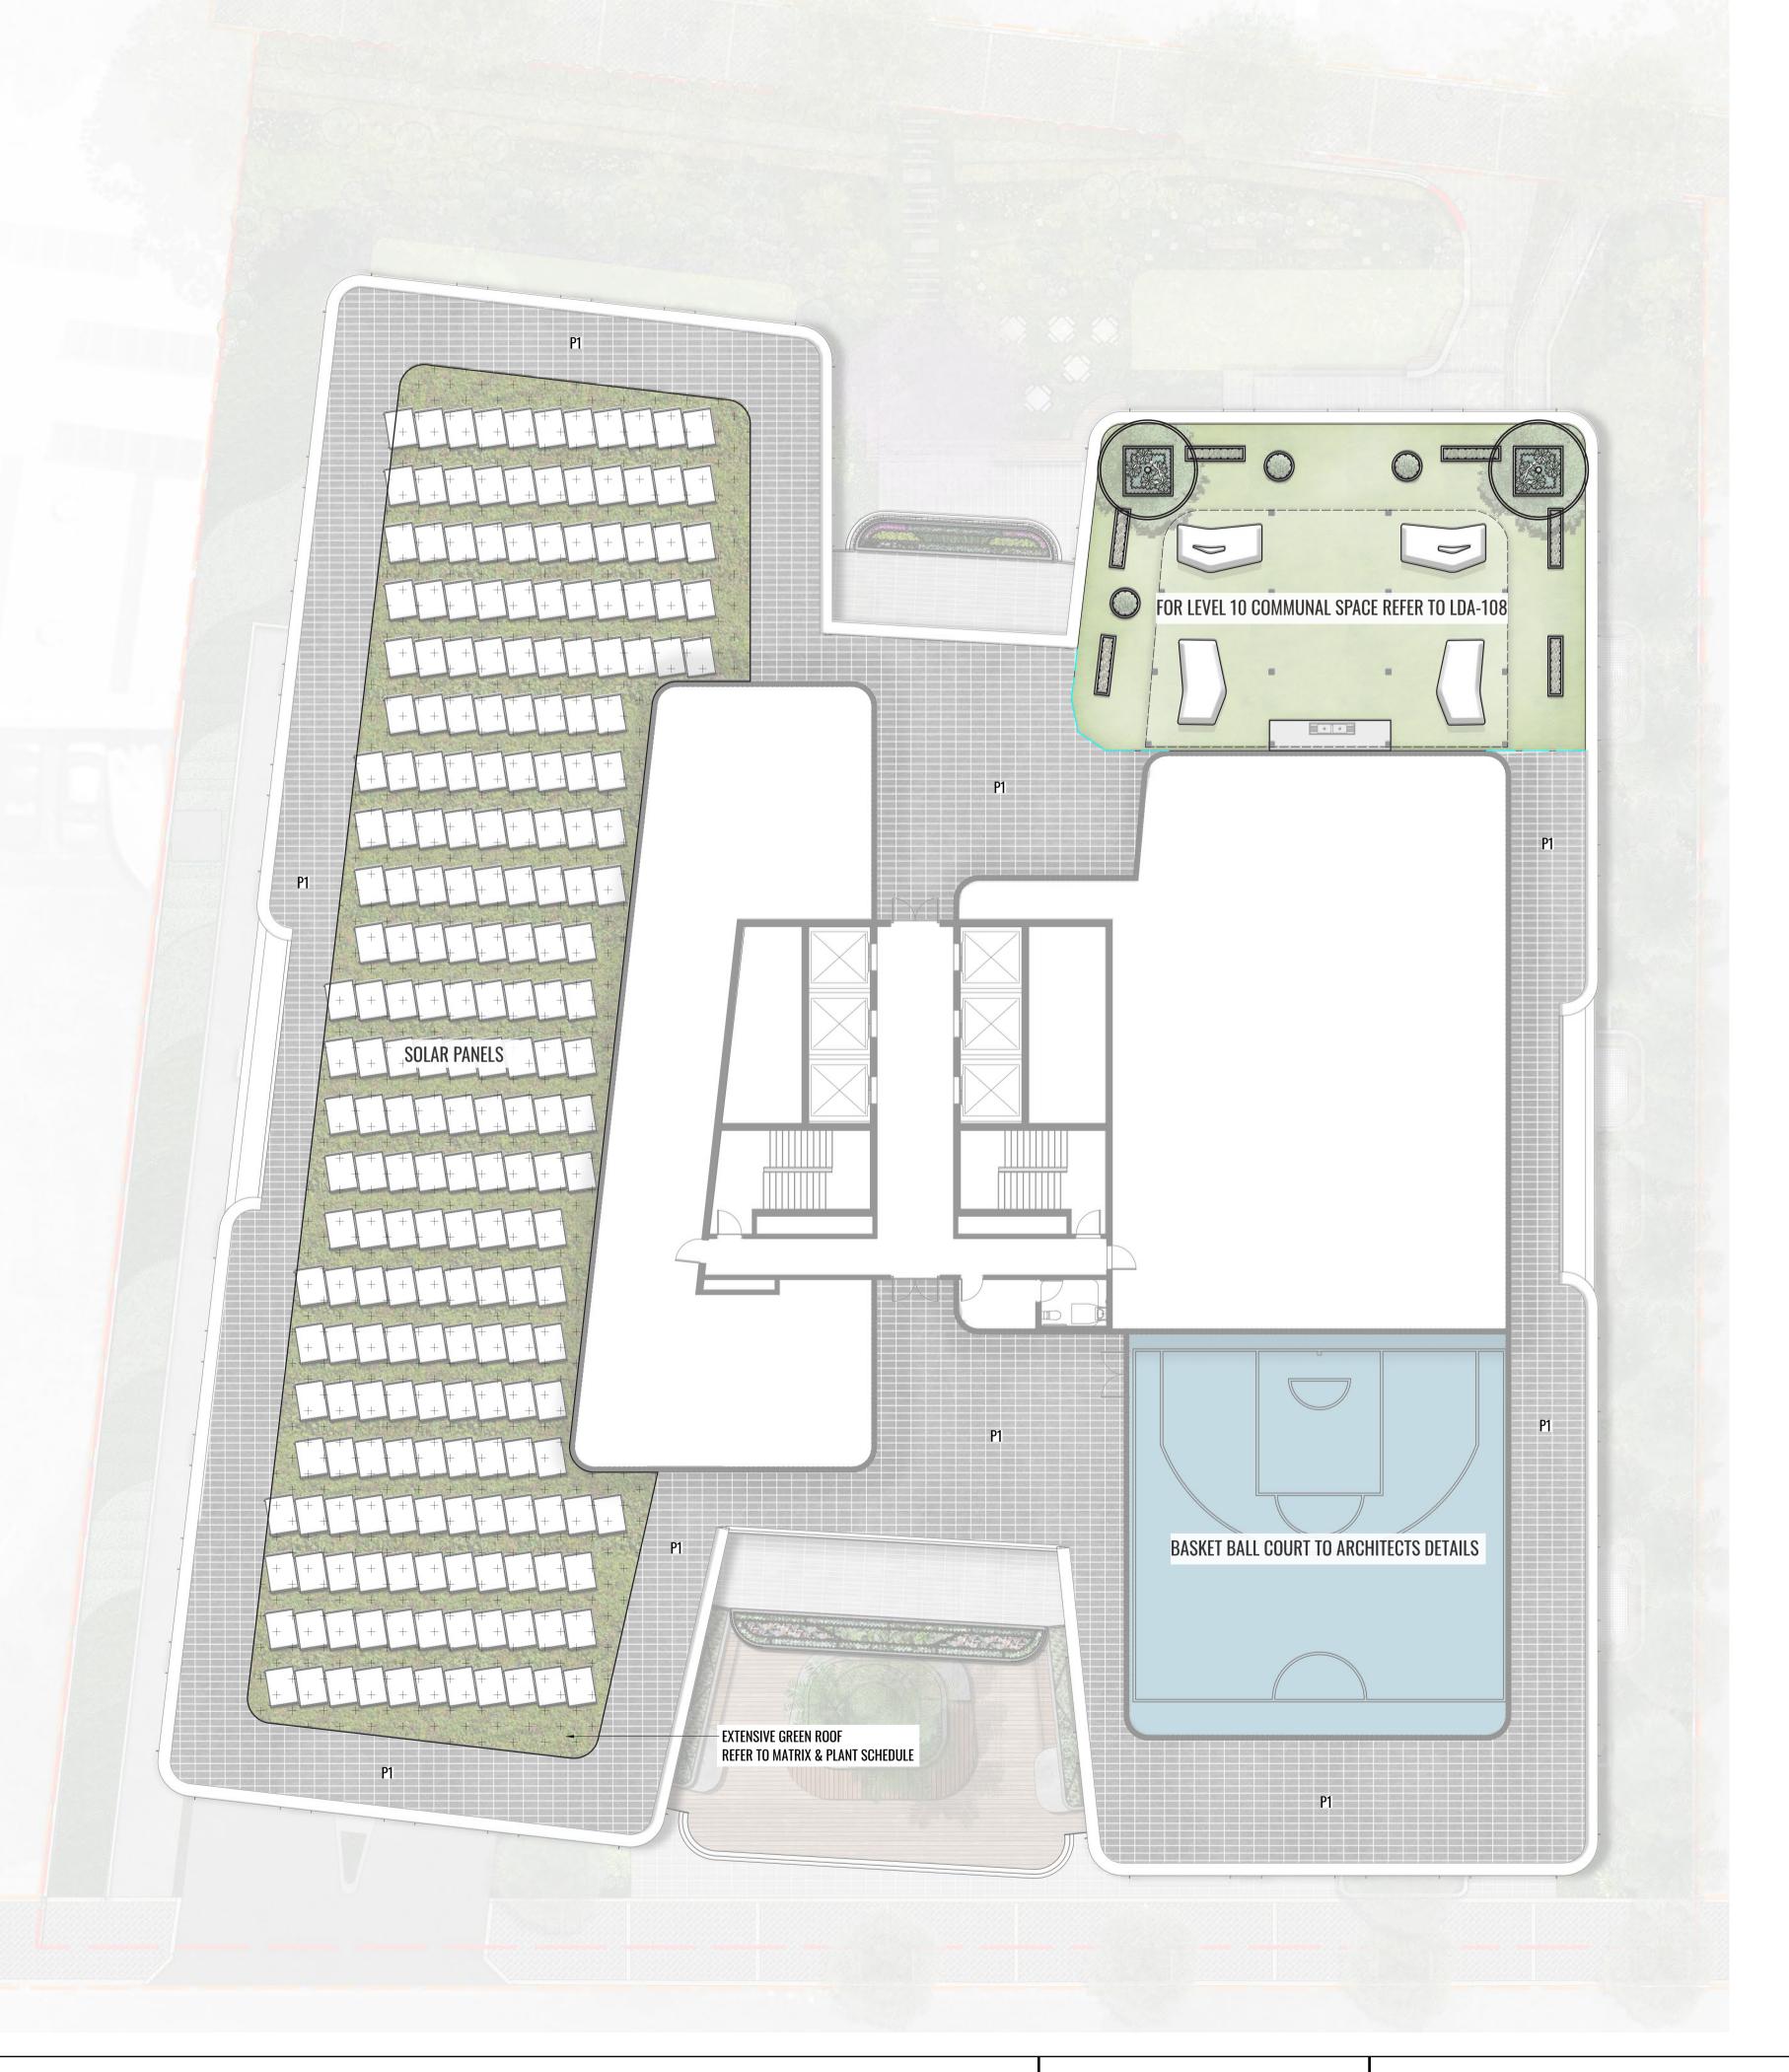






EXTENSIVE GREEN ROOF

P1

800 x 400 x 20mm Porcelain Paver

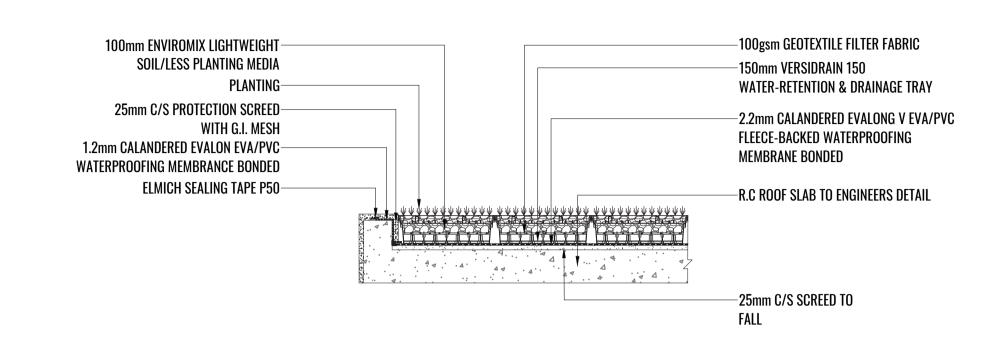

EXTENSIVE GREEN ROOF - TYPICAL DETAIL

Scale 1:20

5000

 Q_D
 Q_{SDM}
 Q_{SDM}
 Q_{SDM}
 Q_D
 Q_D

X EXTENSIVE GREEN ROOF PLANTING MATRIX

Scale 1:20

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Drawing Title:

LEVEL 10 GREEN ROOF

Detail Plan & Details

DWG No:


LDA-107

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Project:	32 KIC	cketty St		C	27.05.21	FOR DA		PT	BG	
			Mascot, NSW 2020							

CG - Carpobrotus GT - Gazania


SGM - S. 'Gold Mound' SBF - S. 'Blue Feather' SDB - S. 'Dragon's Blood' SGRM - S. 'Green Mound'

TYPICAL 5x5m (25m2) PLANTING MATRIX. MATRIX TO BE APPLIED OVER EXTENSIVE GREEN ROOF AREA. NUMBERS SPECIFIED IN PLANT SCHEDULE. REFER TO LDA-112.

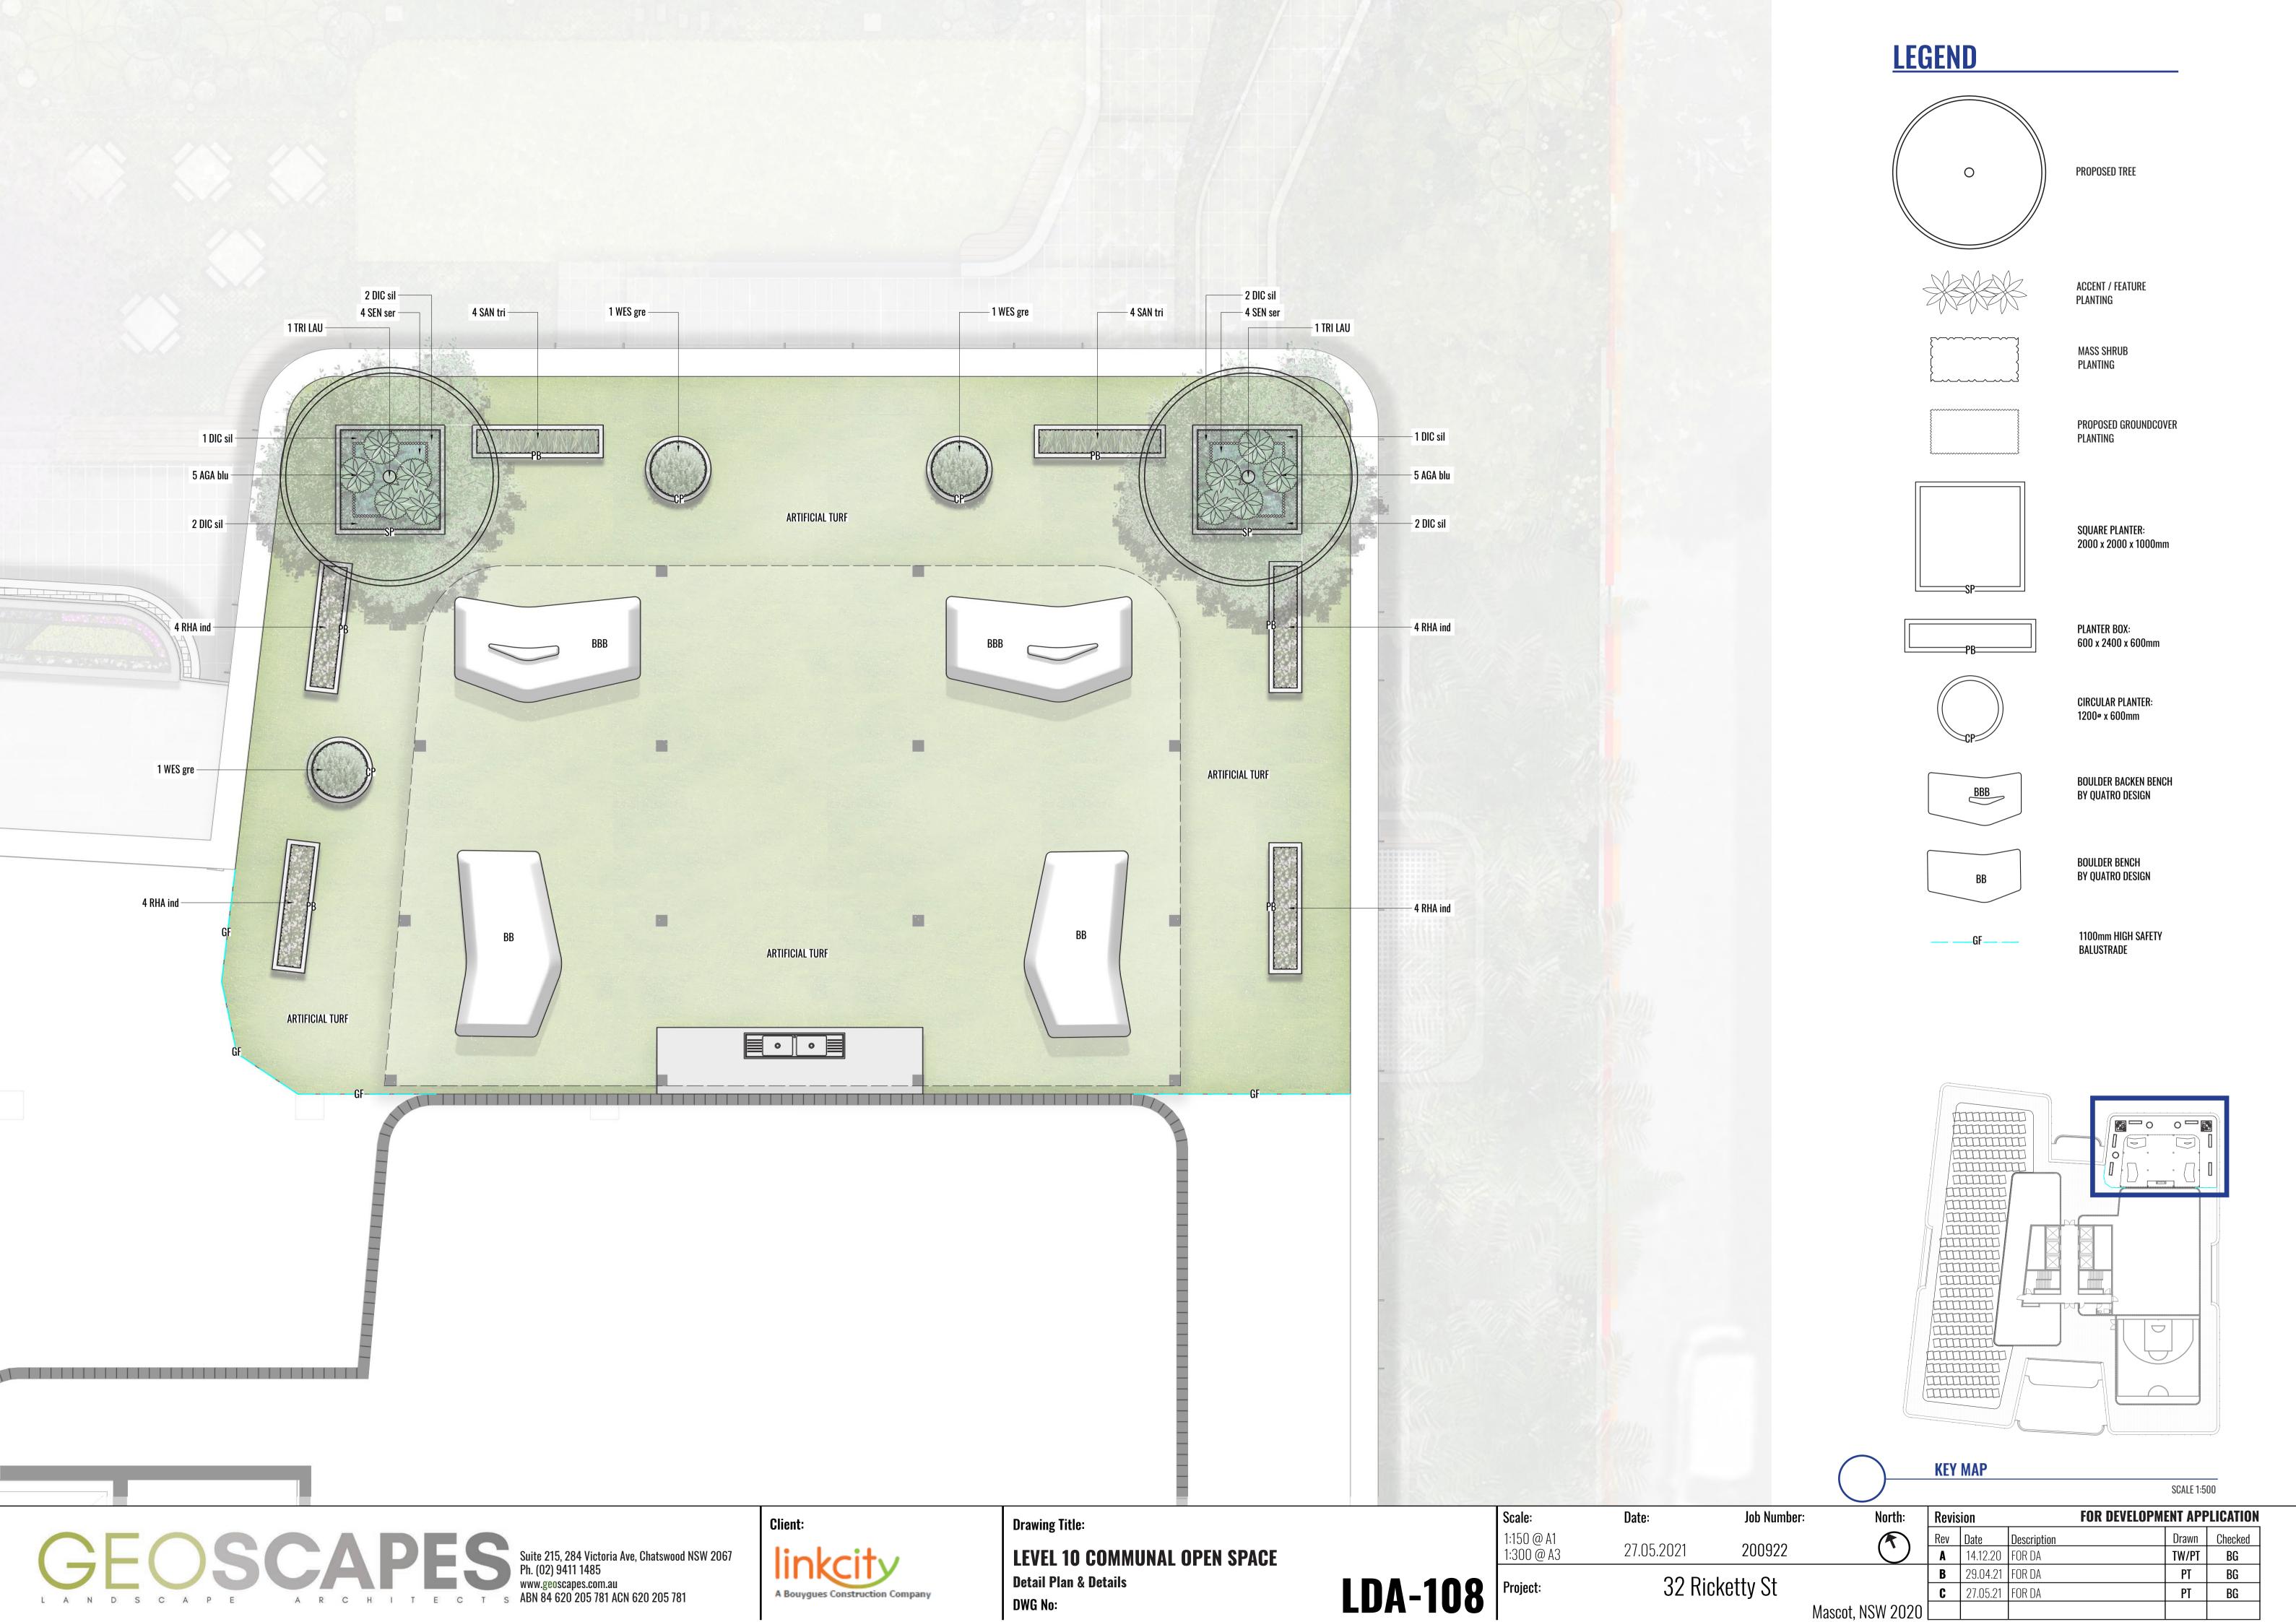

TREE/SHRUB SIZE AND QUALITY TO BE TO NATSPEC STANDARD. SPECIES IS TO BE AS PER PLAN AND PLANT SCHEDULE. ENSURE ONLY HEALTHY AND VIGOROUS, DISEASE FREE, WELL MAINTAINED PLANTS ARE USED.

TAKE CARE TO ENSURE FOLIAGE, BRANCHES, TRUNKS AND ROOT CROWNS ARE NOT DAMAGED BEFORE, DURING AND AFTER PLANTING.

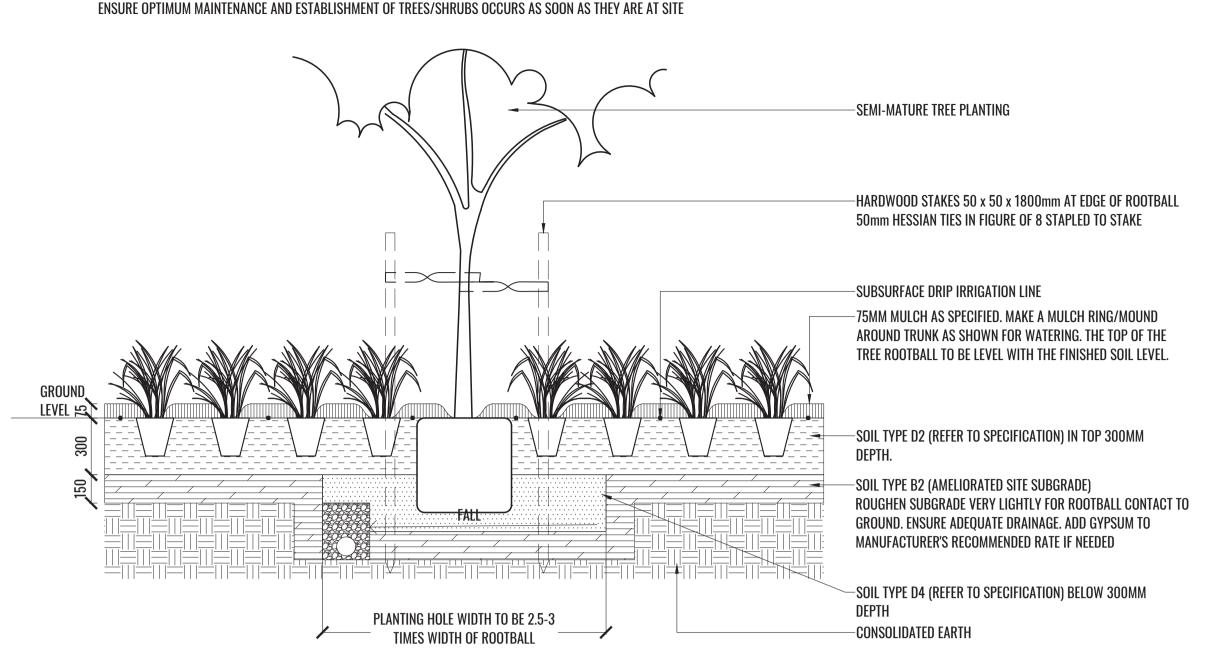


THOROUGHLY SOAK THE ROOTBALL OF TREE WITH FRESH WATER BEFORE TAKING OFF POT OR BAG. WHEN PLANTING HOLE IS COMPLETE USE A SHARP SPADE TO SHAVE OFF 20-50MM OF THE SIDES AND BASE OF ROOTBALL (TO ROOD PRUNE IT) BEFORE CAREFULLY PLACING INTO PLANTING HOLE. IF NORTH IS MARKED ON THE TREE, ENSURE ORIENTATION IS CORRECT WITH NORTH MARKING TO THE NORTH.

- REMOVE ANY STAKES, TIES AND LABELS. WATER ROOTBALL THOROUGHLY.
- TOP OF ROOTBALL TO FINISH FLUSH WITH TOP OF SOIL

MASS PLANTING - TYPICAL DETAIL

Scale 1:20

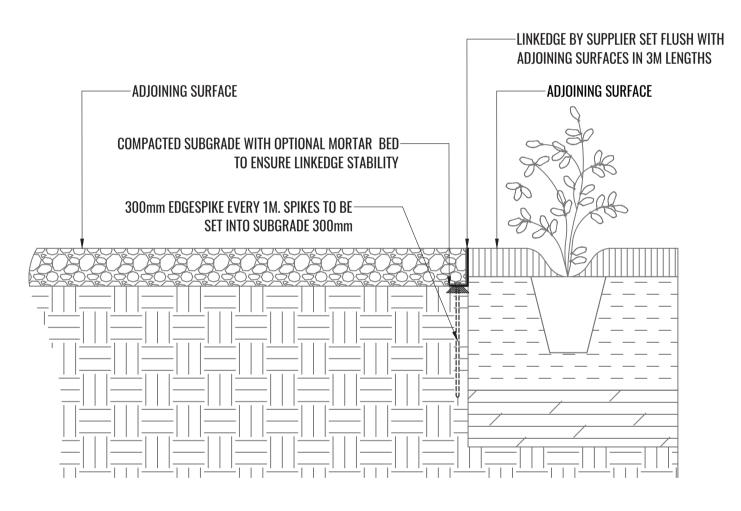

ALUMINIUM EDGE - TYPICAL DETAIL

NATSPEC QUALITY PLANTS TO BE INSTALLED. FOR PLANT SPECIES, QUANTITIES AND SIZE, REFER TO LANDSCAPE PLAN AND -SUBSURFACE DRIP IRRIGATION LINE -75MM MULCH AS SPECIFIED. -SOIL TYPE D2 (REFER TO SPECIFICATION) IN TOP 300MM DEPTH. -SOIL TYPE B2 (SITE SUBGRADE PREPARATION) -CONSOLIDATED EARTH

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WEST OVERLAND FLOW CORRIDOR - TYPICAL DETAIL

Scale 1:20




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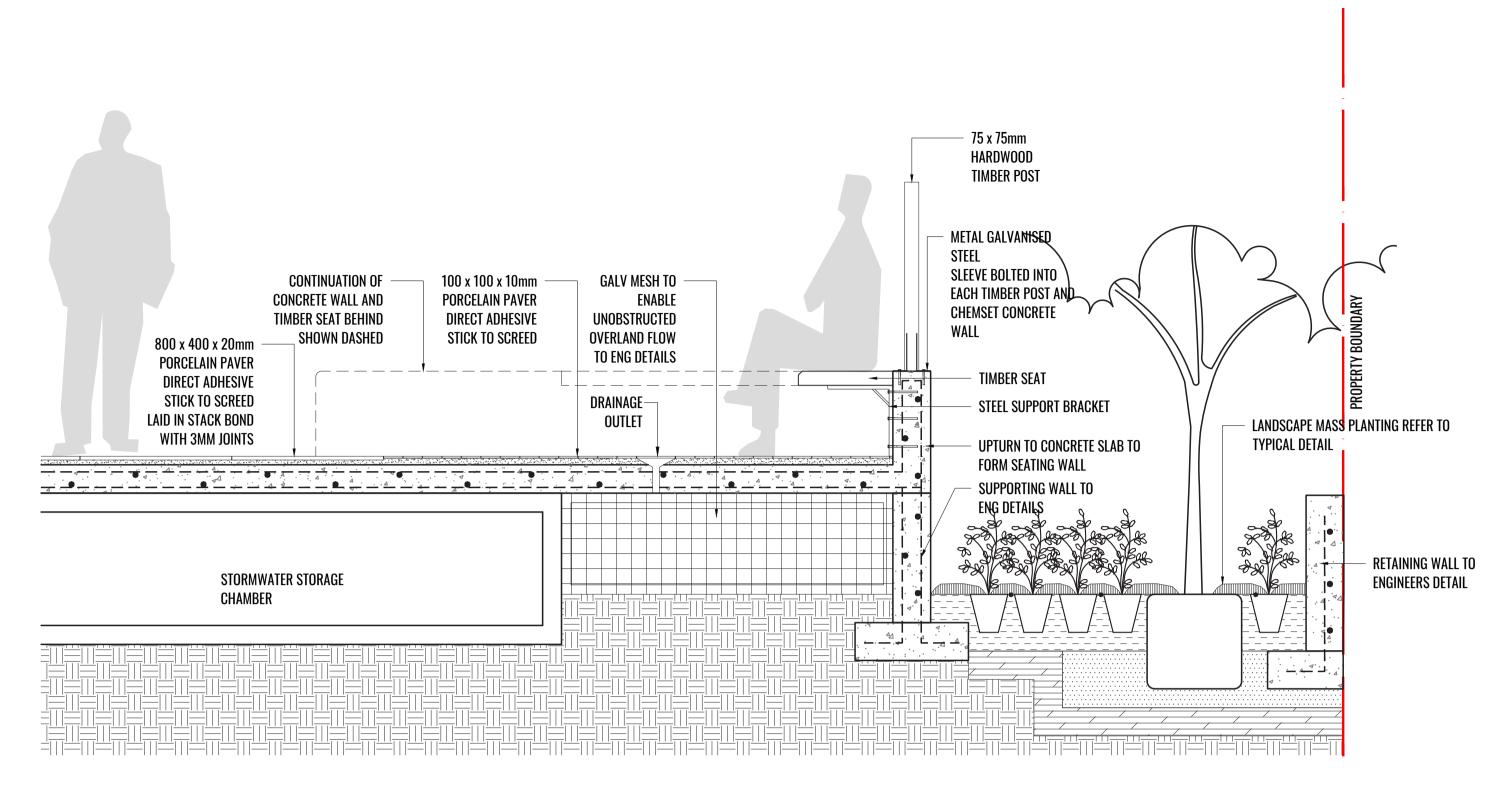


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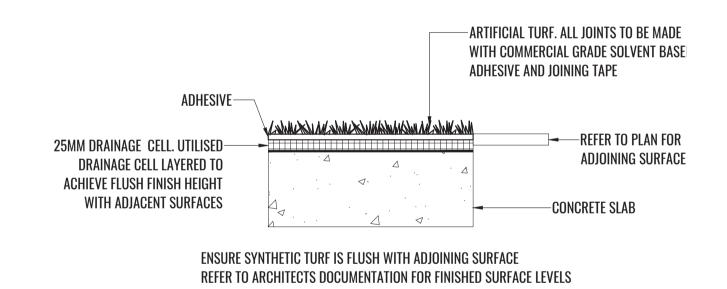
LDA-109 Project:






TYPICAL SECTION DETAIL THROUGH GROUND FLOOR EASTERN LINK SEATING POD

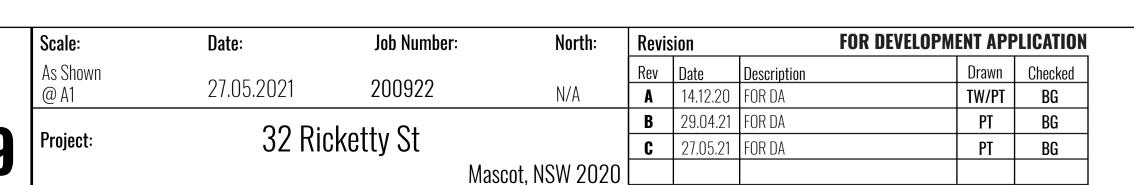Scale 1:20





ARTIFICIAL TURF - TYPICAL DETAIL

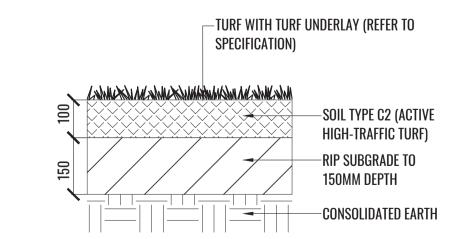

TURF - TYPICAL DETAIL


Scale 1:10

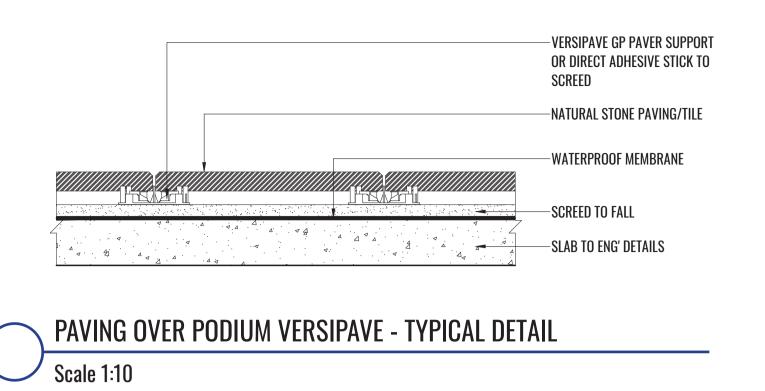


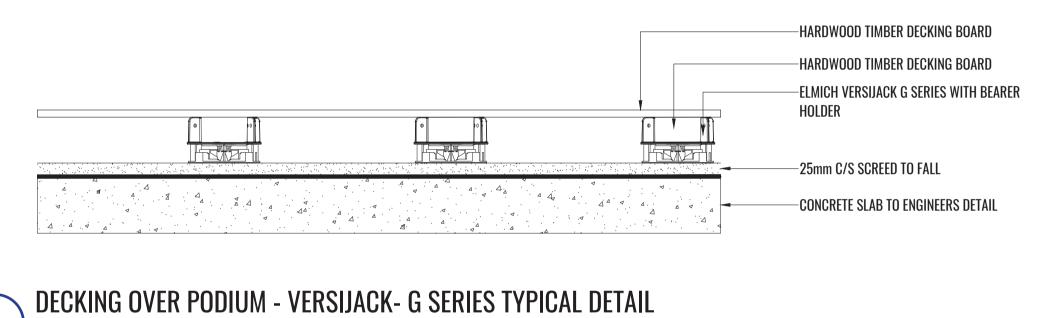


DECKING OVER PODIUM - VERSIJACK- G SERIES TYPICAL DETAIL

Scale 1:10

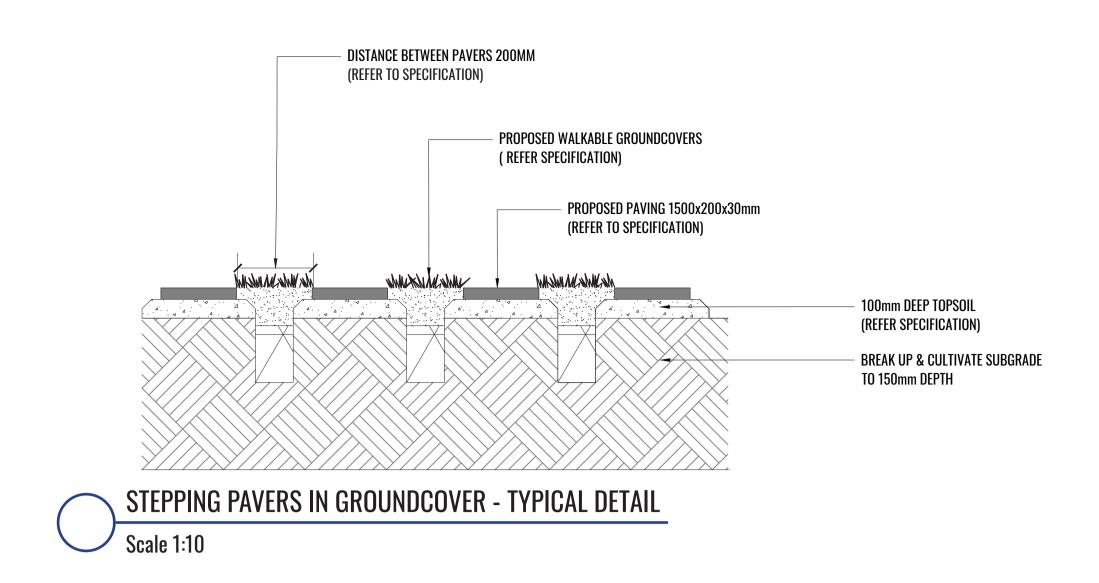

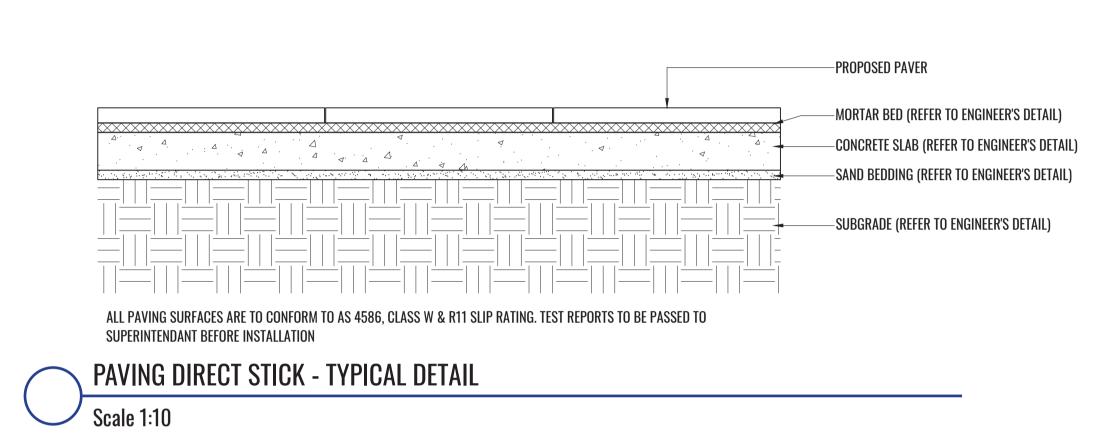

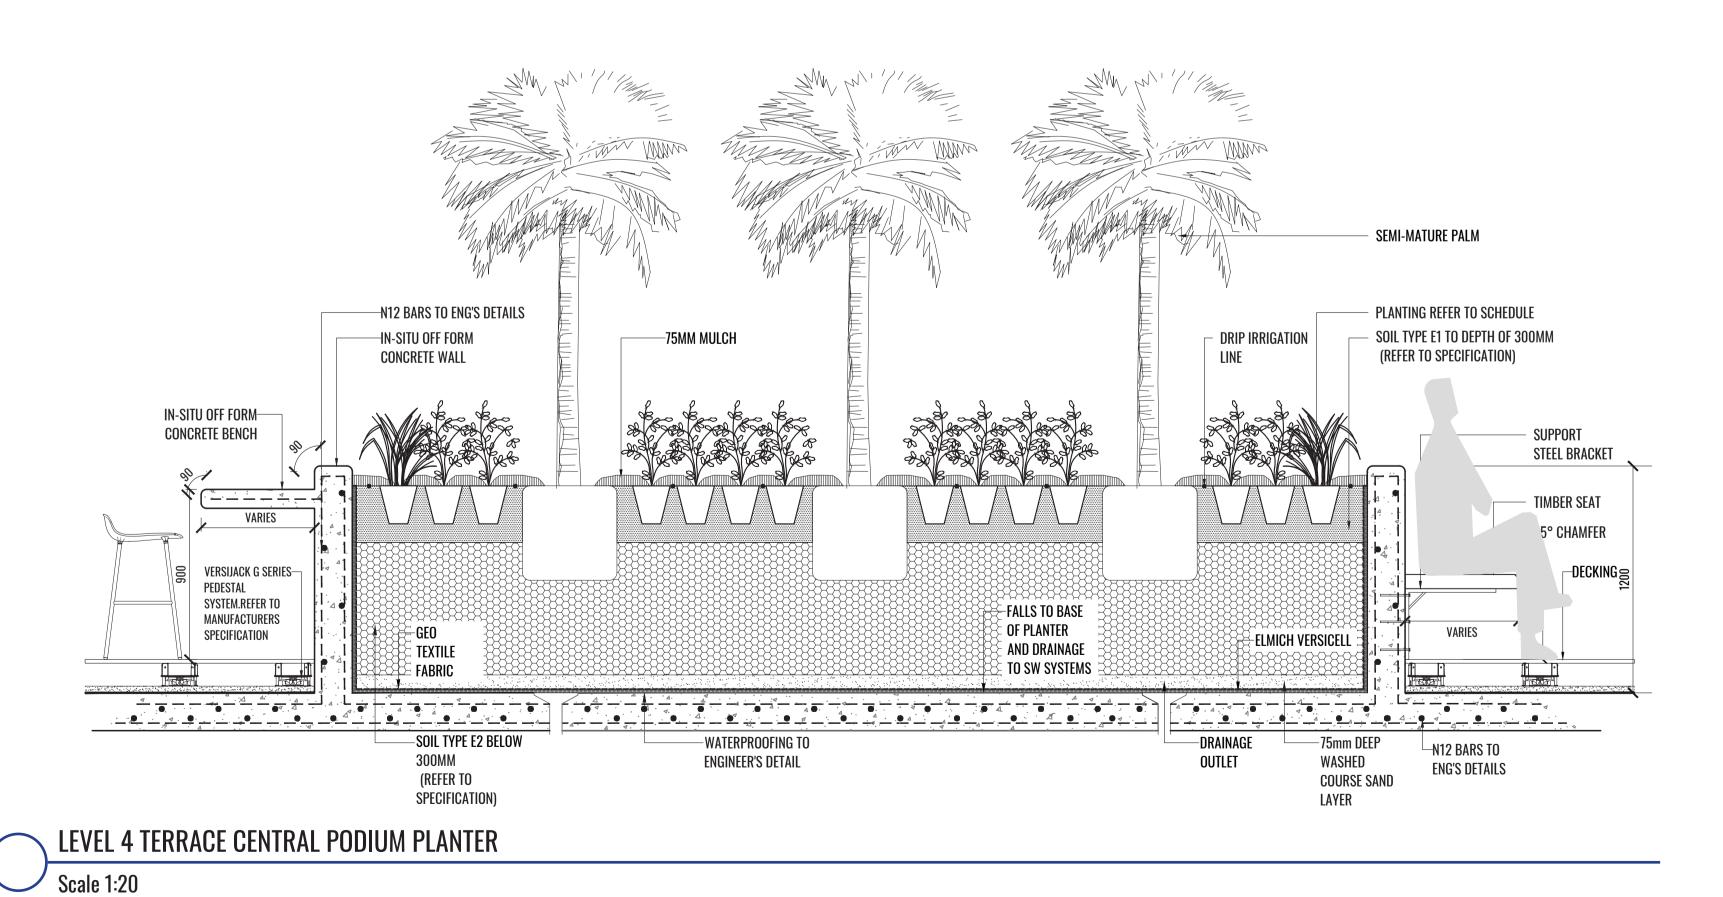

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Drawing Title:

LANDSCAPE DETAILS SHEET 2

DWG No:

LDA-110

Scale:	Date:	Job Number:	North:	Revis	sion		FOR DEVELOPMI	ENT APP	LICATION
As Shown	07.05.0001	000000		Rev	Date	Description		Drawn	Checked
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Project:	32 KIO	cketty St		C	27.05.21	FOR DA		PT	BG
			Mascot NSW 2020						

LANDSCAPE MAINTENANCE PLAN AND SPECIFICATION

Maintenance shall mean the care and maintenance of the landscape works by accepted horticultural practice as rectifying any defects that become apparent in the landscape works under normal use. The landscape contractor shall attend the site on a **weekly basis** to maintain the landscape works commencing from practical completion.

Rubbish Removal

The Landscape Contractor shall undertake rubbish removal from the site on a **weekly basis** to ensure the site remains in tidy condition.

Weed Eradication

Weed growth that may occur in grassed, planted or mulched areas is to be removed using environmentally acceptable methods i.e. non-residual glyphosate herbicide (e.g. 'Roundup', applied in accordance with the manufacturer's direction.

Tree Replacement

Trees shall show signs of healthy vigorous growth and be free from disease and not exhibit signs of stress prior to handover to the client. Any trees or plant that die or fail to thrive, or are damaged or stolen will be replaced. Replacement material shall have the initial maintenance period extended in accordance with the landscape contract conditions. Trees and plant materials shall be equal to the minimum requirements of species specified and approved material delivered to site. Should the condition decline from the approved sample the Superintendent reserves the right to reject the tree / plants.

Frequency: as required.

Stakes

Adjust and/or replace stakes and ties where required. Remove staking and guying when instructed by the Superintendent

Pruning

Selective pruning may be required during the establishment period to promote a balanced canopy structure. These activities shall be carried out to the best horticultural and industry practice. All pruned material is to be removed from site.

Mulched Surfaces

All planter beds and garden areas shall have a minimum depth of 75mm organic mulch. All mulch is to be free of deleterious matter such as soil, weeds, sticks and should conform to AS 4454. Mulched surfaces are to be kept clean and tidy and free of any deleterious material and foreign matter. Reinstate depths to a uniform level of 75mm with mulch as specified, mulch to be free of any wood material impregnated with CCA or similar toxic treatment. Top up mulch levels prior to handover to client & estate management.

Watering

Implement an appropriate hand watering regime in areas not irrigated in association with current watering programme to maintain plant health and vigour. The program shall reflect seasonal conditions and plant species.

Frequency: Weekly or as required.

Soil In Natural Ground (D2)

Non-Australian native garden beds to have imported soil equal or equivalent to 'Organic Garden Mix' as supplied by Australian Native Landscapes. Australian native garden beds to have soil installed consisting of 50% existing site topsoil and 50% new topsoil equal or equivalent to 'Native Low 'P' Mix' as supplied by Australian Native Landscapes. Soil to conform to AS4419.

Pest and Disease Control

The Landscape Contractor shall spray for pests and disease infestations when the pest and fungal attack has been positively identified and when their populations have increased to a point that will become detrimental to plant growth. Apply all pesticides to manufacturer's directions.

Frequency: weekly inspection

Fertilising

Generally check for signs of nutrient deficiencies (yellowing of leaves, failure to thrive), and adapt fertiliser regime to suit. Fertiliser should be applied at the beginning and the end of the (summer) growing season.

Irrigation

A sub surface dripper style, electrically automated self timed irrigation system is to be supplied to all garden bed areas and planter container. Regular checks are to be made to ensure continued successful operation. The Landscape Contractor shall be responsible for coordination and engagement of a specialist irrigation designer and installation contractor to design, supply and install an automatic subterranean drip irrigation system to all raised planter beds.

The irrigation system will need to provide designated landscaped areas with enough water for vigorous healthy plant growth. As a general rule landscaped areas will need 20-25mm, species dependant, of water per week. The landscape Contractor will need to monitor natural rainfall using a rain switch in order to set irrigation flow rates accordingly on a monthly basis.

Standards

All grown or purchased plant stock must conform to all the conditions and requirements given in NATSPEC Guide: Specifying Trees. Soils to be in accordance with AS4419, mulching composts and conditioners to be in accordance with AS4454. Soils should conform to best practice specifications as listed in the Landscape Soils Handbook (Simon Leake & Elke Haege 2017).

Record Keeping

The landscape maintenance works that are carried out in accordance with the management plan are to be recorded in a log book by the Contractor responsible for landscape maintenance. The records shall include details of materials and procedures used as well as time and method of application. A record of inclement weather should also be kept verifying inability to carry out work within the specified time frame. A summary report of landscape maintenance works completed is to be prepared at the end of each month and annually by the Contractor.

ſ	CATEGORY	TASKS						TIMEF	RAMES / FREQUENCY
<u> </u>			Monthly	Spring	Summer	Autumn	Winter	As Required	Specification
ape	1. Weeding	Weed garden areas manually or with approved							Prior approval required for Herbicide use.
		herbicide							Approved Herbicide use to be in accordance with regulation rates and manufacturer's
									recommendation.
			V						Protect plants from overspray and avoid if rain is likely within 12 hour period
ŀ	2. Leaf Litter Removal	Do not remove leaf litter from planted areas							
		unless depth of litter is impacting on plant							
		growth							
		Remove leaf litter from pathways	V						
		The state of the s							
ŀ	2 Mulahina	Doopply mulch to maintain to a depth of 75mm							Loof litter muleh (20, 40mm)
	3. Mulching	Reapply mulch to maintain to a depth of 75mm		1					Leaf litter mulch (20-40mm)
ł	4. Plant Fertiliser	Fertilise all plants at specified rates based on							Prior approval required for fertiliser use.
		soil testing results							Slow release fertiliser N:P:K ratio – 18:3:10 at manufacturer's recommended rate per plant.
				V					Initial fertilising at planting based on soil testing results
ıd	5. Pest & Disease Control	Check for incidence of fungal and insect attack	✓						
}		Avoid use of chemical sprays							Prior approval required of chemical to be applied
		Apply appropriate treatment for fungal and						1	Thor approverrequired or enormed to be applied
		insect attack if necessary subject to approval							
Ī	6. Pruning & Trimming	THOOGE ALCOUNT HOSOCOCAL V SUBJECT TO ABBITOVAL							
}	Shrubs & groundcovers	Tip prune to encourage density. Length removed							
	omase a greanacevere	depending on vigour of previous plant growth	√				1	✓	
all	Trees	Remove deadwood, remove suckering roots from rootball, check ties						\checkmark	Notify in writing to Buildign Management any perceived need for tree structural work
ŀ	7. Plant Removal & Repalcements	Inspect for failed or dying plants requiring							
	·	replacement and record probable cause	1						
		Replant after dead or failed plant removal							Densities, sizes and species to be in accordance with Landscape Plans LCC-000 and relevant
								V	drawing sheet no.
	8. Weed Control in Turf	Remove weeds from turf areas manually or							Prior approval required for Herbicide use.
		with approved herbicide in accordance with							
		manufacturer's recommendations.						V	
ŀ	9. Turf Feriliser	Apply fertiliser at rates as recommended by							Prior approval required for feriliser use.
		manufacturer		1		1			
ļ	10. Turf Mowing	Mow frequency as specified according to the							Every 2 weeks in summer
		season							Every 3 weeks in spring & autumn
de		Mow at heights of between 40 to-60mm &							Every month in winter
1		remove no more than 1/3 of the leaf blade at							Do not mow under wet conditions
		any one time							
	11. Turf Decompaction & Aeration	Inspect for compaction and thatching							
				1					
		Carry out aeration treatment if required		1					Carrry out with dethatching or verticutting equipment
,	12. Turf Replacement	Inspect for failed turf requiring replacement and							
	12. Turi NopiaoGiliGill	record probable cause							
		ו סטטו ע או טאמאוס טמעאס					V		
ł		Remove failed turf, prepare surface & lay new							
oe		turf in accordance with original turf specified in							
h		the landscape plans						V	
ng Title) :		Scale		Date	:	Jo	b Number:	North: Revision FOR DEVELOPMENT APPLICATION
			As St	nown	07.0	NE 0001	0.4	2000	Rev Date Description Drawn Checked





Drawing Title:

LANDSCAPE MAINTENANCE PLAN &
SPECIFICATION NOTES
DWG No:

LDA-111

Scale:	Date:	Job Number:	North:	Revis	sion	FOR	DEVELOPMENT AP	PLICATION
As Shown	07.05.0004	00000		Rev	Date	Description	Drawn	Checked
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Project:	32 KIC	ketty St		C	27.05.21	FOR DA	PT	BG
			Mascot, NSW 2020					

PLANT SCHEDULES

Code	Botanical Name	Common Name	Expected	Install Size	Spacing	Quantity	ESBS*	 Nativ
		John Hallio	Mature Height	IIIJuli VIZU	- opaoms	quantity	2000	Mativ
Public Do								
	TREES							
ELA RET	Elaeocarpus reticulatus 'Prima Donna'	Blueberry Ash	4-5m up to 8m	400L	As Shown	4		✓
WAT FLO	Waterhousea floribunda 'Green Avenue'	Weeping lily Pilly	8-15m	400L	As Shown	4		✓
Ground F								
	TREES							
DIC ANT	Dicksonia antarctica	Soft Tree Fern	3-10m	25L	As Shown	9		✓
ELA RET	Elaeocarpus reticulatus 'Prima Donna'	Blueberry Ash	4-5m up to 8m	100L	As Shown	14		✓
LEP PER	Lepidozami perofskyana	Cycad Palm	3-5m	25L	As Shown	6		✓
	SHRUBS							
ACA cog	Acacia cognata 'Limelight'	River Wattle	1m	300mm	3/m2	36		✓
ACM smi	Acmena smithii 'Hot Flush'	Lilly Pilly	1.2m**	300mm	750mm Ctrs	60		✓
ART cir	Arthropodium cirratum	NZ Rock Lily	0.6m	300mm	500mm Ctrs	27		
CAL dub	Calochlaena dubia	Bracken Fern	0.6-2m	300mm	500mm Ctrs	56		✓
CRI pen	Crinum pendunculatum	Swamp lily	1.5-3m	300mm	750mm Ctrs	42		✓
HEL gla	Helmholtzia glaberrima	Stream Lily	1-2m	200mm	750mm Ctrs	51		✓
HEL psi	Heliconia psittacorum 'Andromeda'	Andromeda Heliconia	1m	300mm	3/m2	8		
HYM fla	Hymenosporum flavum 'Gold Nugget'	Native Frangipani	0.5-0.75m	300mm	As Shown	98		✓
LEP lae	Leptosermum laevigatum 'Shore Tuff'	Coastal Tea Tree	0.3-0.5m	140mm	As Shown	83	✓	✓
MEL squ	Melaleuca squamea	Swamp Honey Myrtle	1.2m**	Tube	As Shown	5	✓	✓
PHI xan	Philodendron 'Xanadu'	Xanadu Philodendron	0.5-0.8m	300mm	4/m2	6		
PTE esc	Pteridium esculentum	Bracken	0.75m	Tube	500mm Ctrs	28	✓	✓
WES blu	Westringia 'WESO3'	Blue Gem Westringia	1-1.5m	300mm	As Shown	27		✓
WES gre	Westringia fruticosa 'WESO4'	Grey Box Westringia	0.3-0.45m	300mm	As Shown	86		✓
WES zen	Westringia fruticosa 'Zena'	Native Rosemary	0.6-0.9m	300mm	As Shown	29		✓
	ACCENT PLANTS							
ASP aus	Asplenium australasicum	Birds Nest Fern	0.5-1m	300mm	As Shown	39		✓
CON tax	Conospermum taxifolium	Yew-Leaf Smoke Bush	1m	Tube	5/m2	153	✓	√
DOR exc	Doryanthes excelsa	Gymea Lily	2-4m	300mm	As Shown	12		✓
SAN tri	Sansevieria trifasciata 'Laurentii'	Striped Snake Plant	1.2m	200mm	4/m2	8		
XAN res	Xanthorrhoea resinosa	Spear Grass Tree	2m	300mm	As Shown	8	✓	√
	GRASSES AND GROUNDCOVERS							
ADI aet	Adiantum aethiopicum	Maindenhair Fern	0.2-0.4m	140mm	6/m2	79		✓
ANG IiI	Anigozanthos flavidus 'Landscape Lilac'	Kangaroo Paw	0.5-0.7m	140mm	4/m2	99		√
CAR app	Carex appressa	Tall Sedge	0.8-1m	140mm	4/m2	97		√
CAR gla	Carpobrotus glacescens 'CAR10'	Aussie Rambler' Native Pig Face	0.2m	140mm	3/m2	15		√
CAS gla	Casuarina glauca 'Cousin It'	Cousin It	0.3m	140mm	4/m2	75		√
CAU pen	Caustis pentandra	Thick Twistrush	0.12	140mm	4/m2	90	✓	✓
DIA rev	Dianella revoluta 'DRGO4'	Revelation' Dianella	0.5m	140mm	4/m2	242	✓	√
DIC cri	Dichelachne crinita	Longhair Plumegrass	0.3-1.2m	140mm	4/m2	118	✓	√
DIC rep	Dichondra repens	Kidney Weed	0.2m	140mm	6/m2	151		√
DOO asp	Doodia aspera	Prickly Rasp Fern	0.4m	140mm	4/m2	73		√
FIC nod	Ficinia nodosa	Knobby Club Brush	0.8-1m	140mm	5/m2	102		√
LOM eve	Lomandra labill 'LM600'	Evergreen Baby Lomandra	0.4-0.45m	140mm	5/m2	270		√
LOM tan	Lomandra longifolia 'LM300'	Lomandra Tanika	0.5-0.6m	140mm	4/m2	196	√	· ✓
SCA aem	Scaevola aemula 'Surdiva White'	Fan Flower	0.3-0.0m 0.1-0.2m	140mm	3/m2	74		· ✓
SCA alb	Scaevola albida 'Mauve Clusters'	Fan Flower	0.1-0.2m	140mm	3/m2	20		· ✓
oon aib	ออลองอเล สามานสาพาสนางิธ อาณิจิเฮาจ	Native Violet	0.1-0.2iii	140mm	3/m2	192		→

^{*} Eastern Suburbs Banksia Scrub **To be trimmed to height indicated

Code	Botanical Name	Common Name	Expected Mature Height	Install Size	Spacing	Quantity	Native
Level 1 to	o 3 Carpark Terraces						
	SHRUBS						
PHI pri	Philodendron 'Prince Of Orange'	Prince of Orange	0.4-0.6m	140mm	450mm Ctrs	657	
	CLIMBERS						
PAN jas	Pandorea jasminoides 'Southern Belle'	Bower of Beauty	0.5-0.8m	200mm	Spacing @400mm	657	✓


Code	Botanical Name	Common Name	Expected Mature Height	Install Size	Spacing	Quantity	Native
Level 4 T	errace						
	TREES						
ARC ALE	Archtophoenix alexandrea	Bangalow Palm	6.0 - 10.0m	100L	As Shown	3	✓
	SHRUBS						
HYM fla	Hymenosporum flavum 'Gold Nugget'	Native Frangipani	0.5-0.75m	300mm	500mm Ctrs	45	✓
PHI con	Philodendron 'Congo' (Chinese Clone)	Chinese Congo	0.6-0.8m	300mm	600mm Ctrs	8	✓
PHI pri	Philodendron 'Prince Of Orange'	Prince of Orange	0.4-0.6m	300mm	5/m2	42	√
	ACCENT PLANTS						
BLE gib	Blechnum gibbum 'Silver Lady'	Silver Lady Fern	1m	300mm	4/m2	29	
ASP den	Asparagus densiflorus 'Myersii'	Foxtail Fern	0.6-0.8m	300mm	5/m2	13	
SAN tri	Sansevieria trifasciata 'Laurentii'	Striped Snake Plant	1.2m	200mm	4/m2	9	
	GRASSES AND GROUNDCOVERS						
CAL orb	Calathea orbifolia	Peacock Plan	0.2-0.5m	140mm	5/m2	62	
CAR ros	Carpobrotus rossii	Pig Face	0.2 - 0.4m	140mm	175mm Ctrs	5	✓
DIC sil	Dichondra argentea 'Silver Falls'	Silver Falls	0.2m	140mm	4/m2	2	
ROS off	Rosmarinus officinalis 'Prostratus'	Creeping Rosemary	03-0.6m	140mm	250mm Ctrs	3	
SCA aem	Scaevola aemula 'Surdiva White'	Fan Flower	0.1 - 0.2m	140mm	175mm Ctrs	4	✓
TRA mat	Trachelospermum jasmonoides	Star Jasmine	4.0 - 6.0m	140mm	500mm Ctrs	40	✓

Code	Botanical Name	Common Name	Expected Nature Unight	Install Size	Spacing	Quantity	Native
Level 5 to	O 9 Terrace		Mature Height				
	SHRUBS						
PHI bla	Philodendron erubescens 'Black Cardinal	Black Cardinal	0.5m	300mm	600mm Ctrs	50	✓
PHI con	Philodendron 'Congo' (Chinese Clone)	Chinese Congo	0.6-0.8m	300mm	500mm Ctrs	50	✓
	ACCENT PLANTS						
ASP den	Asparagus densiflorus 'Myersii'	Foxtail Fern	0.6-0.8m	300mm	5/m2	40	✓
SAN tri	Sansevieria trifasciata 'Laurentii'	Striped Snake Plant	1.2m	200mm	4/m2	25	
	GRASSES AND GROUNDCOVERS						
CAR ros	Carpobrotus rossi	Pig Face	0.2 - 0.4m	140mm	175mm Ctrs	115	✓
DIC sil	Dichondra argentea 'Silver Falls'	Silver Falls	0.2m	140mm	250mm Ctrs	295	
ROS off	Rosmarinus officinalis 'Prostratus'	Creeping Rosemary	03-0.6m	140mm	250mm Ctrs	75	
SCA aem	Scaevola aemula 'Surdiva White'	Fan Flower	0.1 - 0.2m	140mm	175mm Ctrs	130	✓
TRA mat	Trachelospermum jasmonoides	Star Jasmine	4.0 - 6.0m	140mm	500mm Ctrs	145	✓

Code	Botanical Name	Common Name	Expected Mature Height	Install Size	Spacing	Quantity	Native
Level 10	Communal Open Space						
	TREES						
TRI LAU	Tristaniopsis laurina	Kanooka Gum	12.0 - 15.0m	100L	As Shown	2	✓
	SHRUBS						
WES gre	Westringia fruticosa 'WESO4'	Grey Box Westringia	0.3-0.45m	300mm	As Shown	3	✓
	ACCENT PLANTS						
SAN tri	Sansevieria trifasciata 'Laurentii'	Striped Snake Plant	1.2m	200mm	4/m2	8	
AGA blu	Agave 'Blue Glow'	Blue Glow	0.6m	140mm	As Shown	10	✓
	GRASSES AND GROUNDCOVERS						
DIC sil	Dichondra argentea 'Silver Falls'	Silver Falls	0.2m	140mm	4/m2	10	
RHA ind	Rhaphiolepis indica 'Snow Maiden'	Indian Hawthorn	0.75 - 1.0m	140mm	500mm Ctrs	16	
SEN ser	Senecio serpens	Blue Chalksticks	0.3m	140mm	5/m2	8	✓

Code	Botanical Name	Common Name	Expected	Install Size	Spacing	Quantity	Native
Guut	Dutanical Name	Guilliuli Naille	Mature Height	IIIStali Size	Spacing	Quantity	Native
Level 10 I	Extensive Green Roof						
	GRASSES AND GROUNDCOVERS						
CG	Carpobrotus glaucescens	Pigface	0.3m	50mm	500mm Ctrs	473	✓
GT	Gazania tomentosa	Gazania	0.2m	50mm	500mm Ctrs	473	
SGM	Sedum 'Gold Mound'	Sedum 'Gold Mound'	0.1m	100mm	500mm Ctrs	473	
SBF	Sedum 'Blue Feather'	Sedum 'Blue Feather'	0.1m	100mm	500mm Ctrs	473	
SDB	Sedum 'Dragon's Blood'	Sedum 'Dragon's Blood'	0.1m	100mm	500mm Ctrs	473	
SGRM	Sedum 'Green Mound'	Sedum 'Green Mound'	0.1m	100mm	500mm Ctrs	473	


HARD MATERIAL PALETTE

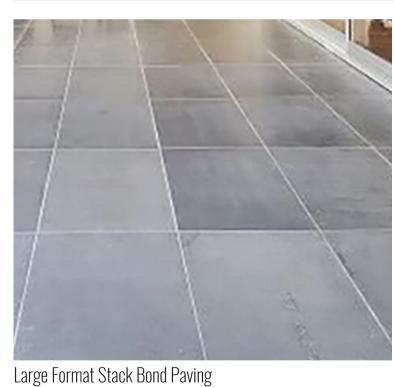





Cantilevered Timber Bench Seats

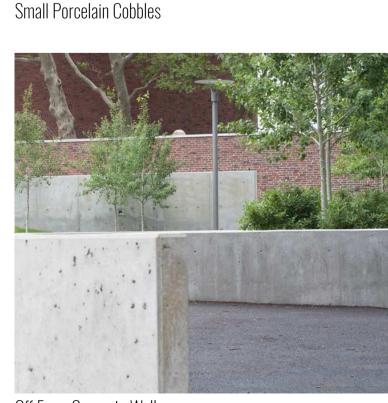

Off Form Concrete Walls

SOFT MATERIAL PALETTE









Waterhousea 'Green Avenue'

Dicksonia antarctica

Elaeocarpus 'Prima Donna'

Acacia 'Limelight'







Calochlaena dubia

Crinium pendunculatum

Helmholtzia glaberrima









Doryanthes excelsa

Xanthorrhoea resinosa

Melaleuca squamea

Westringia 'Zena'

Asplenium australasicum



Anigozanthos 'Landscape Lilac'



Casuarina 'Cousin It'





Carpobrotus 'Aussie Rambler'







A Bouygues Construction Company

Drawing Title:

PLANTING SCHEDULES & HARD AND SOFT MATERIAL PALETTE DWG No:

Lomandra 'Evergreen Baby'